

ELECTRICAL

E1	SITE PLAN, DETAILS	
E2	BASEMENT PLAN	POOL
E3	GROUND FLOOR PLAN	POOL
E4	FIRST FLOOR PLAN	POOL
E5	MAIN FLOOR PLAN - POOL BALCONY	GYMNASIUM
E6	GROUND FLOOR PLAN	GYMNASIUM
E7	FIRST FLOOR PLAN	GYMNASIUM
E8	MAIN FLOOR PLAN	GYMNASIUM
E9	DETAILS, DIAGRAMS	GYMNASIUM
E10	DIAGRAMS	

MECHANICAL

M1	SITE PLAN	
M2	FOUNDATION PLAN	POOL
M3	BASEMENT PLAN	POOL
M4	GROUND FLOOR PLAN	POOL
M5	FIRST FLOOR PLAN	POOL
M6	MAIN FLOOR PLAN	POOL
M7	FOUNDATION PLAN	GYMNASIUM
M8	GROUND FLOOR PLAN	GYMNASIUM
M9	FIRST FLOOR PLAN	GYMNASIUM
M10	MAIN FLOOR PLAN	GYMNASIUM
M11	BALCONY PLAN	GYMNASIUM
M12	DETAILS, DIAGRAMS	GYMNASIUM
M13	DETAILS, DIAGRAMS	POOL
M14	PLUMBING RISER DIAGRAM	POOL
M15	STEAM SERVICE DETAILS	

ARCHITECTURAL

A1	TITLE SHEET & SITE PLAN	
A2	HEAT TUNNEL - DEMOLITION	PHY. ED. BLDG. - HEAT TUNNEL
A3	PH. ED. BLDG. - HEAT TUNNEL	
A4	PH. ED. BLDG. - HEAT TUNNEL	
A5	PH. ED. BLDG. - HEAT TUNNEL	
A6	PH. ED. BLDG. - HEAT TUNNEL	
A7	PH. ED. BLDG. - HEAT TUNNEL	
A8	PH. ED. BLDG. - HEAT TUNNEL	
A9	PH. ED. BLDG. - HEAT TUNNEL	
A10	PH. ED. BLDG. - HEAT TUNNEL	
A11	PH. ED. BLDG. - HEAT TUNNEL	
A12	PH. ED. BLDG. - HEAT TUNNEL	
A13	PH. ED. BLDG. - HEAT TUNNEL	
A14	PH. ED. BLDG. - HEAT TUNNEL	
A15	PH. ED. BLDG. - HEAT TUNNEL	
A16	PH. ED. BLDG. - HEAT TUNNEL	
A17	PH. ED. BLDG. - HEAT TUNNEL	
A18	PH. ED. BLDG. - HEAT TUNNEL	
A19	PH. ED. BLDG. - HEAT TUNNEL	
A20	PH. ED. BLDG. - HEAT TUNNEL	
A21	PH. ED. BLDG. - HEAT TUNNEL	
A22	PH. ED. BLDG. - HEAT TUNNEL	
A23	PH. ED. BLDG. - HEAT TUNNEL	
A24	PH. ED. BLDG. - HEAT TUNNEL	
A25	PH. ED. BLDG. - HEAT TUNNEL	
A26	PH. ED. BLDG. - HEAT TUNNEL	
A27	PH. ED. BLDG. - HEAT TUNNEL	
A28	PH. ED. BLDG. - HEAT TUNNEL	
A29	PH. ED. BLDG. - HEAT TUNNEL	
A30	PH. ED. BLDG. - HEAT TUNNEL	
A31	PH. ED. BLDG. - HEAT TUNNEL	
A32	PH. ED. BLDG. - HEAT TUNNEL	
A33	PH. ED. BLDG. - HEAT TUNNEL	
A34	PH. ED. BLDG. - HEAT TUNNEL	
A35	PH. ED. BLDG. - HEAT TUNNEL	
A36	PH. ED. BLDG. - HEAT TUNNEL	
A37	PH. ED. BLDG. - HEAT TUNNEL	
A38	PH. ED. BLDG. - HEAT TUNNEL	
A39	PH. ED. BLDG. - HEAT TUNNEL	
A40	PH. ED. BLDG. - HEAT TUNNEL	

STRUCTURAL

S1	FOUNDATION PLAN	POOL
S2	FOUNDATION DETAILS	POOL
S3	FOUNDATION DETAILS	POOL
S4	GROUND FLOOR FRAMING PLAN	POOL
S5	FIRST FLOOR FRAMING PLAN	POOL
S6	ROOF, MAIN FLOOR FRAMING PLAN	POOL
S7	ROOF FRAMING PLAN	POOL
S8	STAIR SECTIONS, DETAILS	
S9	FOOTING, FOUNDATION PLAN	GYMNASIUM
S10	EXTERIOR STAIRS, ENTRANCE DETAILS	
S11	ENTRY RAMPS, DETAILS	
S12	ENTRY RAMPS, FOUNDATION PLANS	
S13	FIRST FLOOR FRAMING PLAN	GYMNASIUM
S14	MAIN FLOOR FRAMING PLAN	GYMNASIUM
S15	BALCONY BLEACHERS PLAN, DETAILS	GYMNASIUM
S16	ROOF FRAMING PLAN	GYMNASIUM
S17	GYM TRUSS DETAILS	
S18	BALCONY FRAMING, DETAILS	POOL

SITE PLAN
SCALE 1" = 50'-0"

SYMBOLS

- ROOM NO. (PREFIX "D" DENOTES POOL AREA, "G" WALL EXCEED 10' NO. IN GYM AREA)
- DOOR NUMBER, HARDWARE GROUP, DOOR TYPE
- DETAIL NUMBER, SHEET NUMBER
- SECTION AREA, DETAIL NO., SHEET NUMBER
- ELEVATION NUMBER, SHEET NUMBER
- GRID LINE
- CONSTRUCTION JOINT

MATERIAL LEGEND

- UNLESS OTHERWISE NOTED THE DESIGNATIONS BELOW INDICATE THE FOLLOWING MATERIALS IN SECTION.
- BRICK
 - CONC. BLOCKS
 - CERAMIC TILE
 - CONCRETE
 - WOOD
 - BLOCKWORK
 - GRANITE
 - STEEL
 - TERRAZZO

INSTRUCTIONAL BUILDING FOR PHYSICAL EDUCATION
ST. CLOUD STATE COLLEGE ST. CLOUD, MINN.

DEPT. OF ADMINISTRATION
A. J. NELSON - STATE ARCHITECT


STATE OF MINN.
PROJECT NO. 5425

TRAYNOR & HERMANSON,
JOHNSTON & SAHLMAN
GAUSMAN & MOORE

ARCHITECTS
STRUCTURAL ENGINEERS
MECHANICAL ENGINEERS



SCHEDULE FOR EXTERIOR SITESWORK FINISHES

- A CONCRETE POURED WALLS WITH SMOOTH FLYWOOD FINISH ESTABLISHED AS SHOWN ON ELEVATIONS.
- B CONCRETE (4") OVER GRAVEL POURED ON SLOPES WITH JOINT LINES AS SHOWN
- C CONCRETE (4") SIDEWALKS POURED OVER GRAVEL
- D GRANITE FLAGSTONES OVER WELL COMPACTED FILL AND 2" WASHED GRAVEL, FILL JOINTS WITH GRAVEL
- E GRANITE WASTE MATERIAL
- F DIRECTIONAL BROOMED FINISH CONC. WALKS
- G SOO OVER BLACK TOPSOIL - LAWN AREAS
- H BACKTOP SOIL FOR PLANTING AREAS TO DESIGNATED GRASS HAVE A PERIMETER OF 2"x4" REDWOOD ANCHORED.

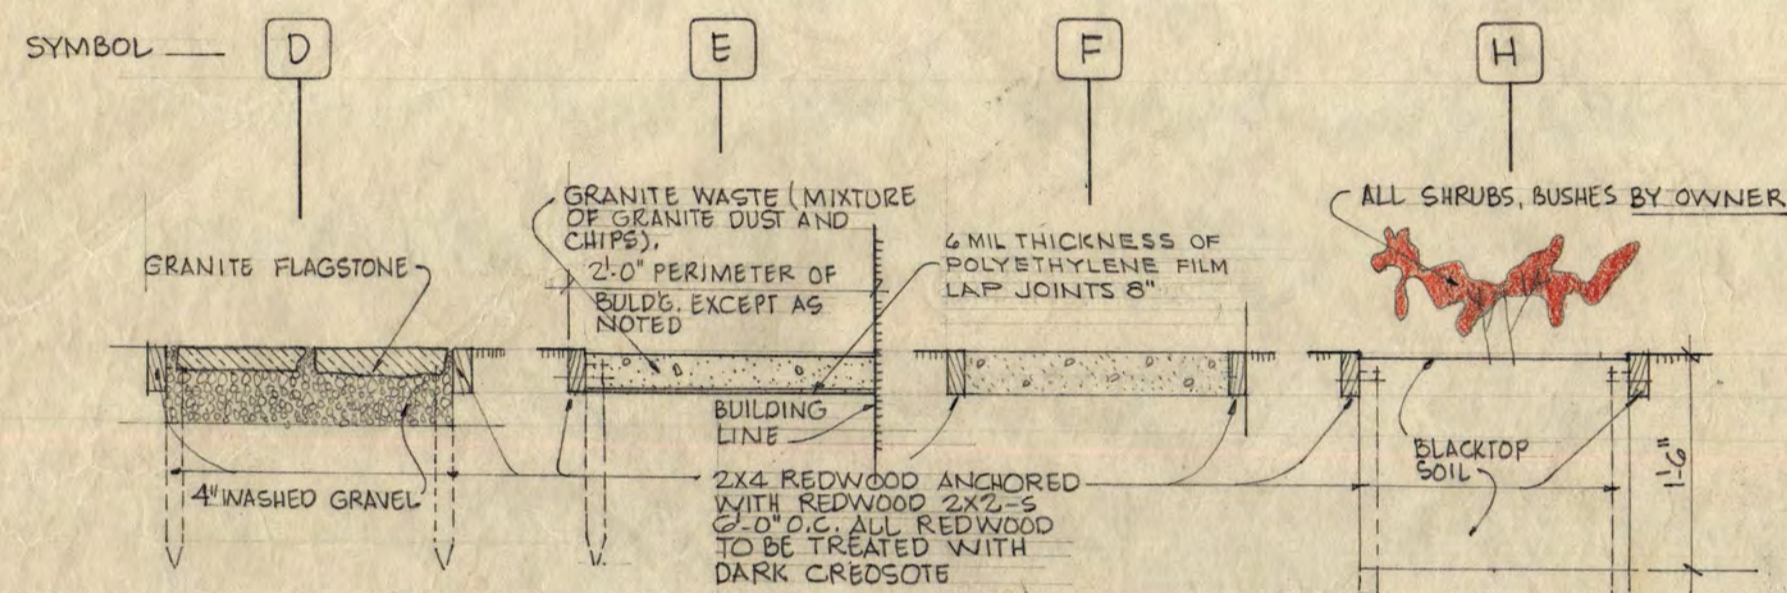

DETAILS FOR EXTERIOR SITESWORK FINISHES SCALE 3/4" = 1'-0"

SOIL TEST DATA

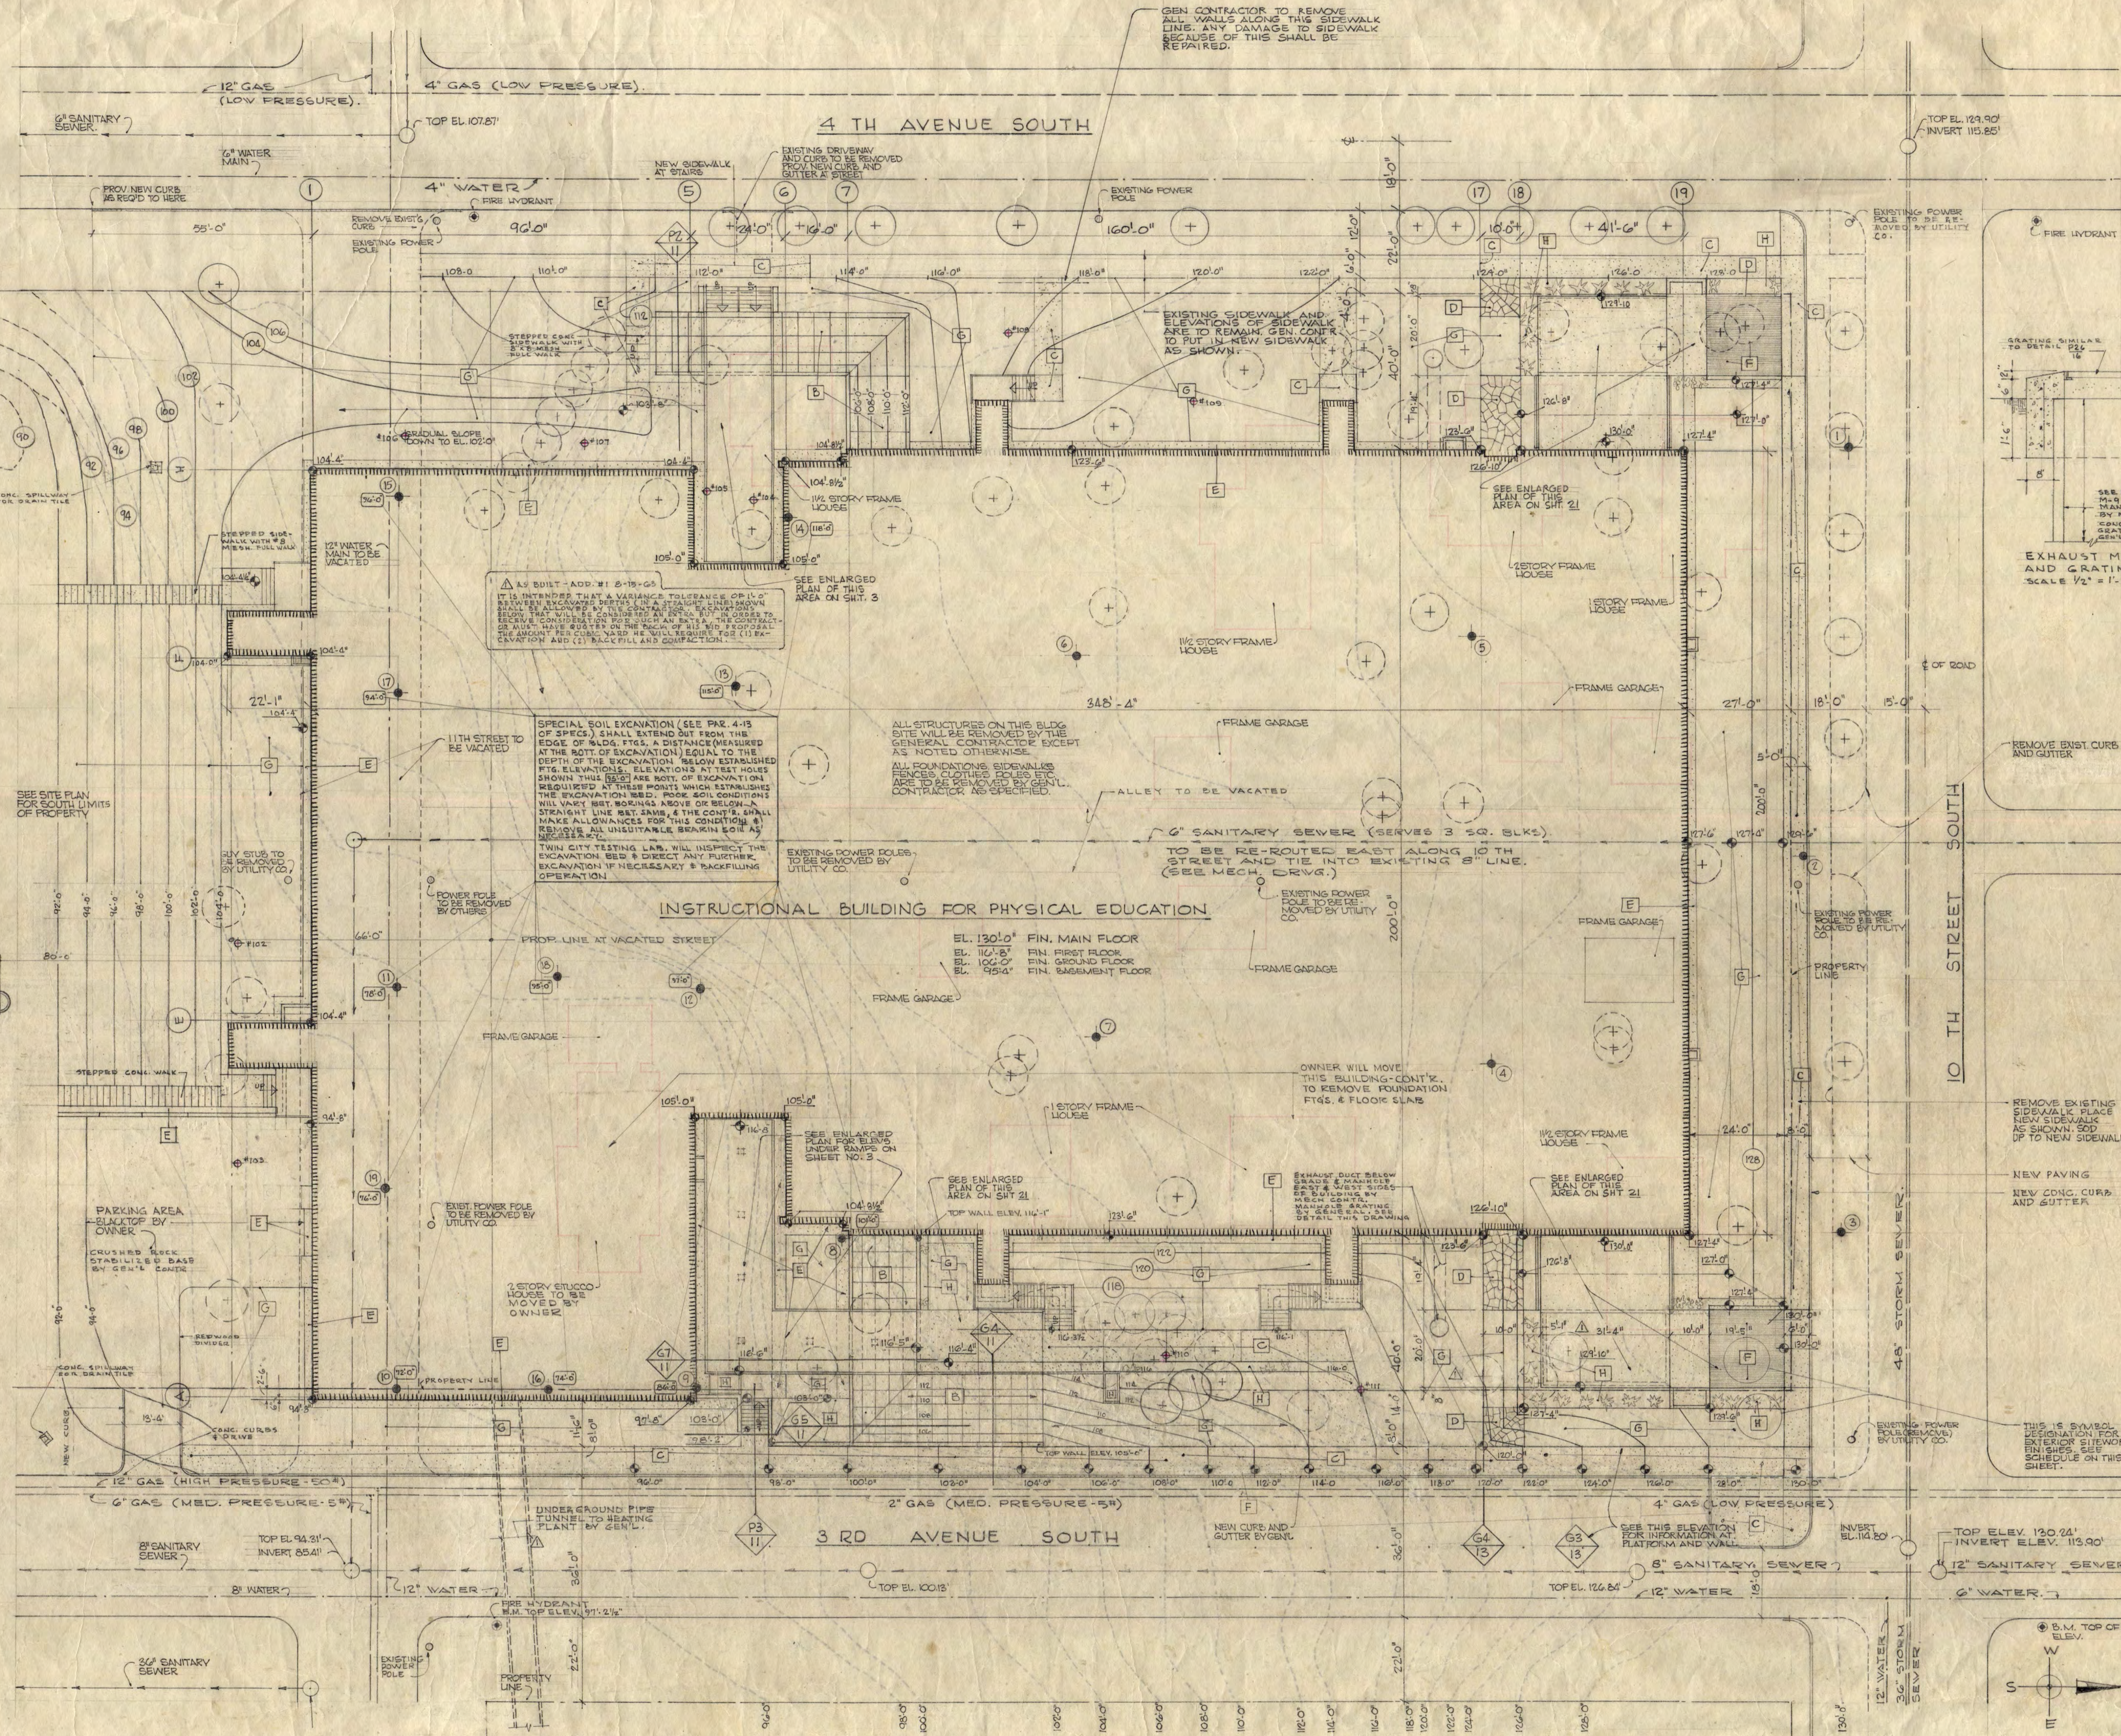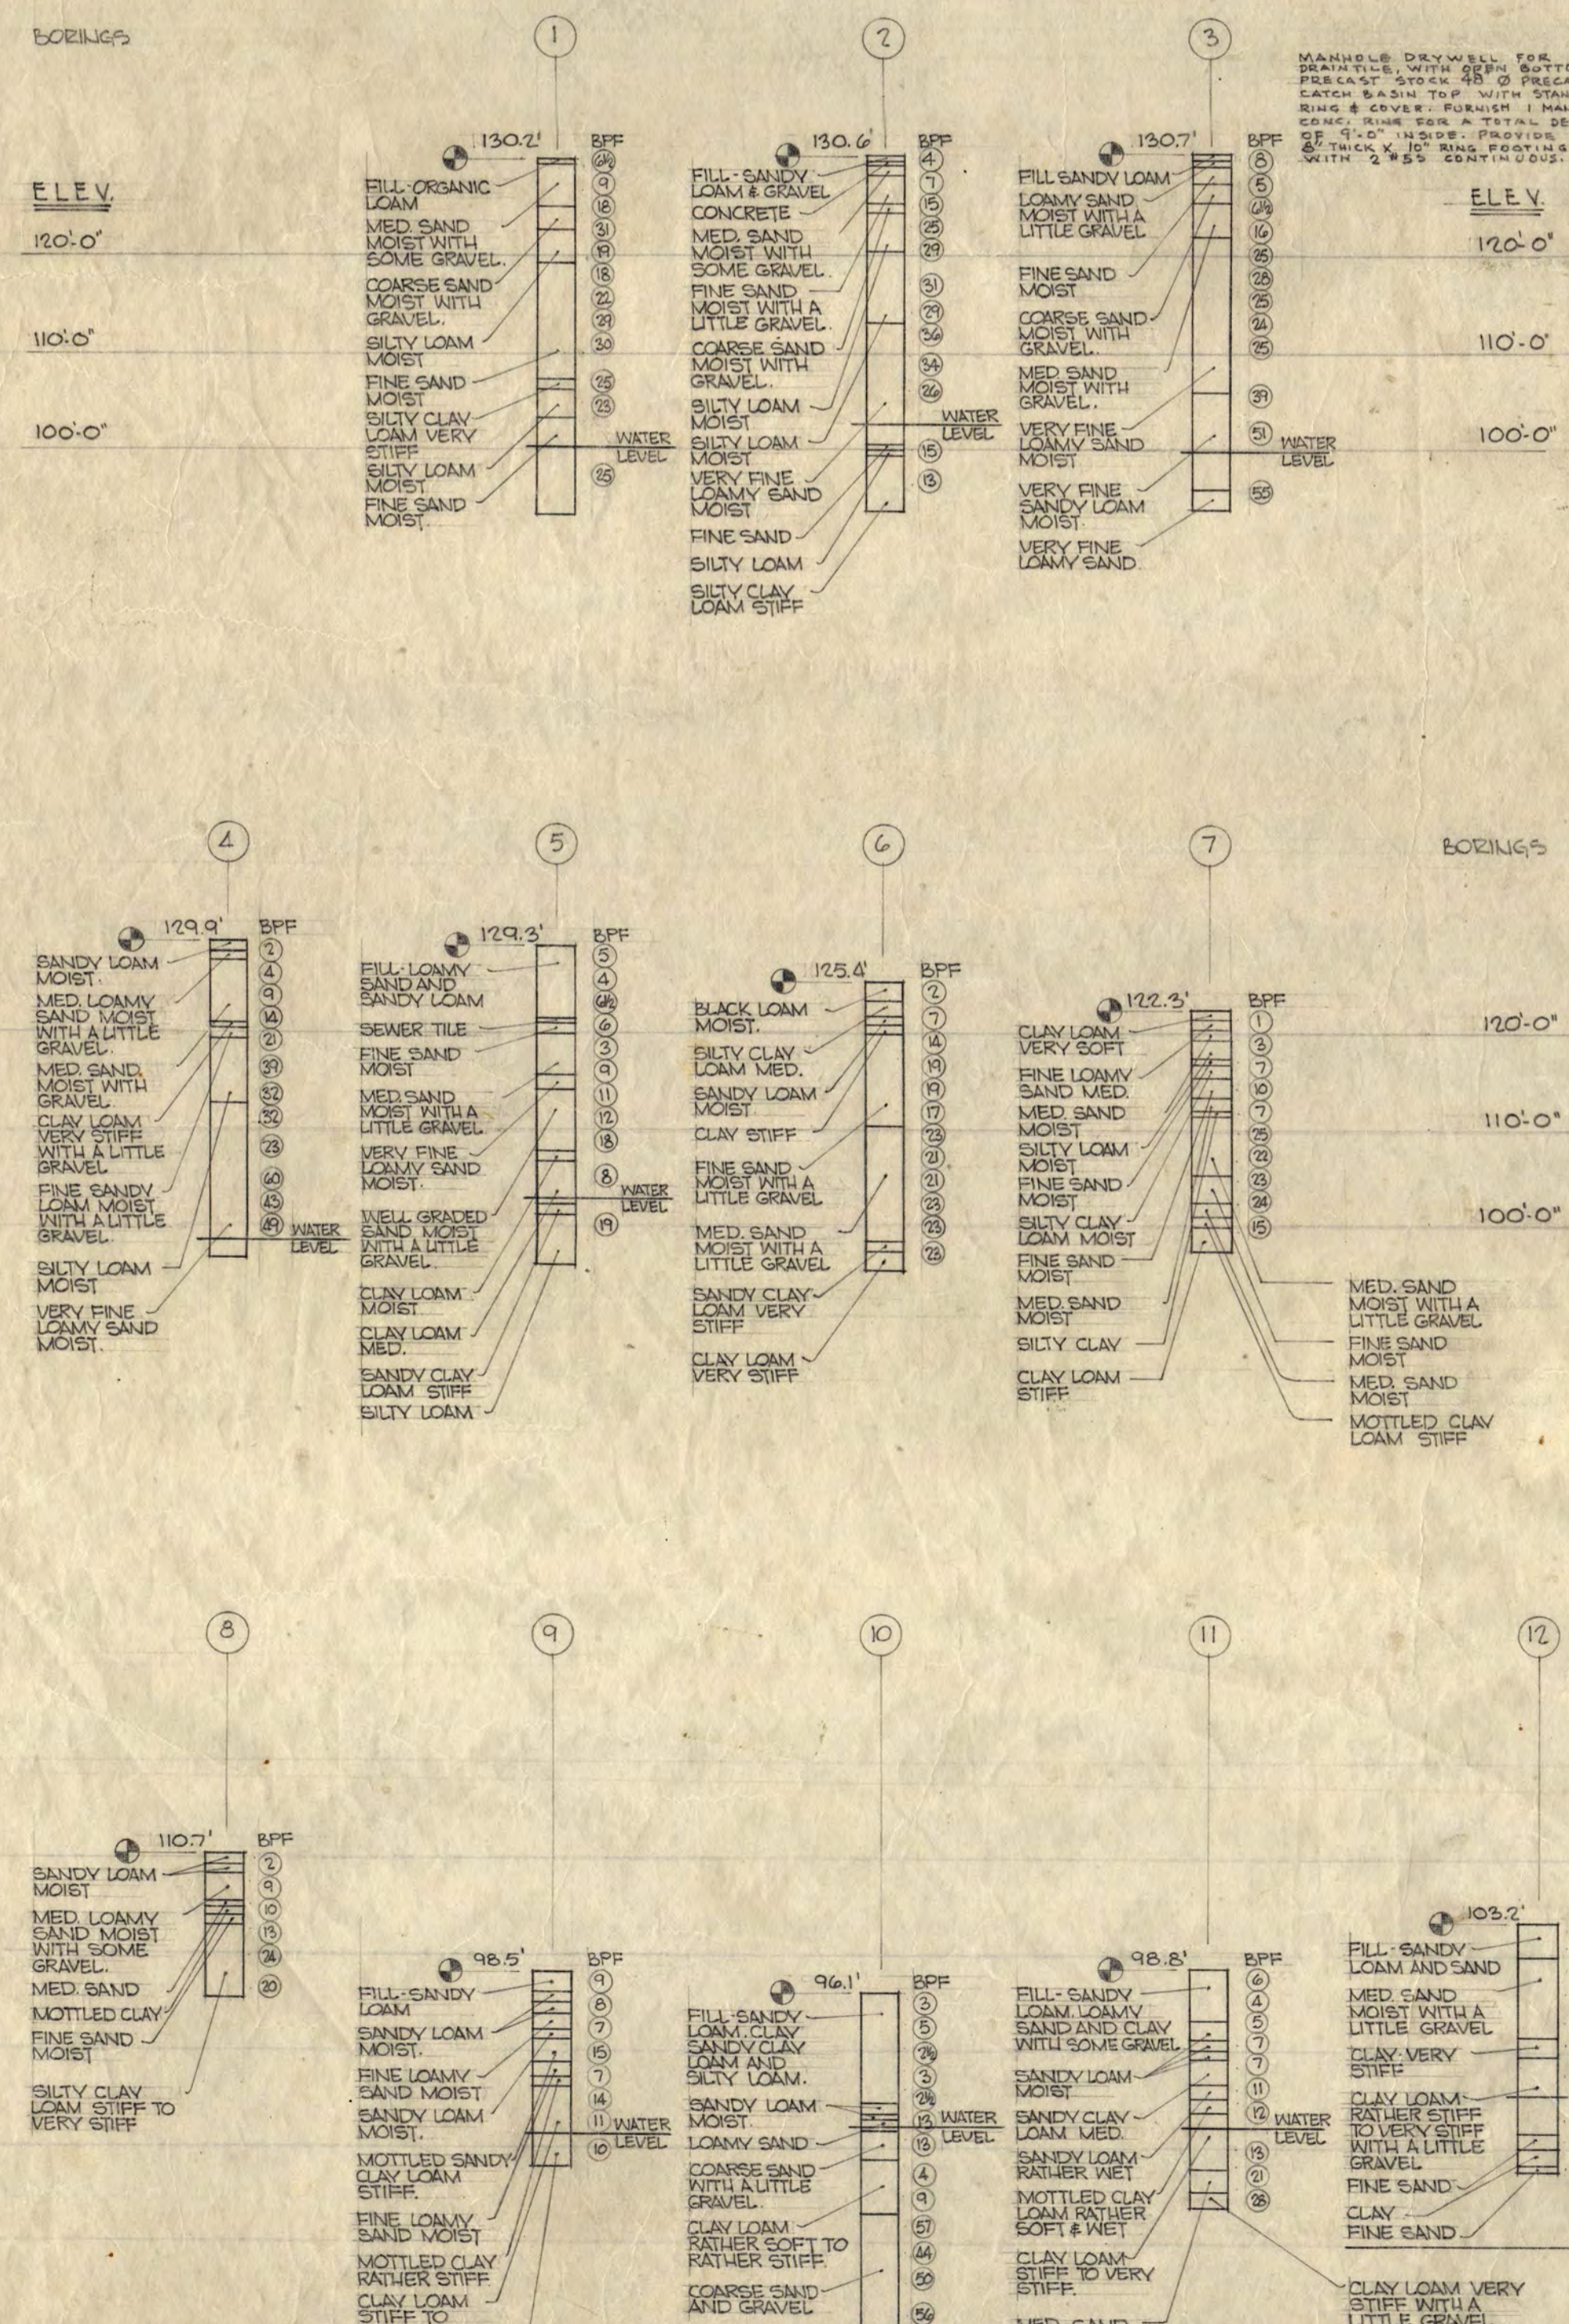

PLOT PLAN SCALE 1/4" = 1'-0"

PLOT PLAN DESIGNATIONS

- EXISTING COLTOURS
- NEW COLTOURS
- ESTABLISHED ELEVATIONS
- TEST HOLE #
- TEST HOLE NUMBER
- PROPERTY LINE
- TREESTOBEY
- TREES TO BE REMOVED

EXPLANATION OF ELEVATIONS

USDS 108434
 PLAN DESIGNATION 18434
 ALL ELEVATIONS NOTED ON PLAN SHALL BE FINISH ELEVATIONS UNLESS OTHERWISE NOTED TO BE OTHER WISE.
 I hereby certify that this plan, specification, or report was prepared by me or under my direct supervision and that I am a duly Registered Architect under the laws of the State of Minnesota.
 Date: 1-17-63 Reg. No. 2823

INSTRUCTIONAL BUILDING FOR PHYSICAL EDUCATION
 ST. CLOUD STATE COLLEGE
 DEPARTMENT OF ADMINISTRATION
 ROOM 126 STATE CAPITOL BUILDING
 ARCHITECTURAL AND ENGINEERING DIVISION
 ST. PAUL, MINNESOTA

STATE OF MINNESOTA
 ST. PAUL, MINNESOTA

APPROVED BY: *Raymond J. Hermanson*
 ARCHITECT

APPROVED BY: *A. J. Nelson*
 STATE ARCHITECT

PLOT PLAN

TRAYNOR AND HERMANSON ARCHITECTS ST. CLOUD
 STRUCTURAL ENGINEERS: JOHNSON & CARLSON MINNEAPOLIS, MINN.
 CONSULTING ENGINEERS: GAUSMAN & MOORE, INC. ST. PAUL, MINN.



DATE: 1-17-63
 DRAWN: L.W. TWB RAS TJD RPT
 CHECKED: _____

ROOM FINISH SCHEDULE


KEY TO SYMBOLS

FLOOR	BASE	WALLS	CEILING	PAINT
C = CONCRETE	CB = CONCRETE	CB = CONCRETE	PL = PLASTER	
T = TERRAZZO	T = TERRAZZO	GT = GLAZED TILE	P = PLASTER	
AT = ASPHALT TILE	R = RUBBER	B = BRICK		
PT = PLASTIC TILE	CT = CERAMIC TILE	C = CONCRETE		
V = WOOD		P = PLASTER		

NO	NAME	FLOOR	BASE	WALLS	CLG	PAINT	REMARKS
P-01	STORAGE ROOM	C		C	C		
P-02	RECEIVING ROOM	C		C, CB	C		
P-03	MECHANICAL ROOM	C		C, CB	C		
P-04	POOL EQUIPMENT RM.	C		C, CB	C		
P-05	ELECTRICAL VAULT	C		C	C		
P-06	TRANSFORMER	C		C	P		
P-07	STORAGE AREA	C		C, CB	C		
P-08	CORRIDOR	C		C	C		
P-09	CHLORINE ROOM	C		CB	C		
P-10	CORRIDOR	C		C	C		
P-11	CORRIDOR	C		CB	C		
	STAIR E	C		C	C		
	STAIR H	C		C	C		
	STAIR H-1	C		C	C		
P-12	MACHINE ROOM	C		C	C		

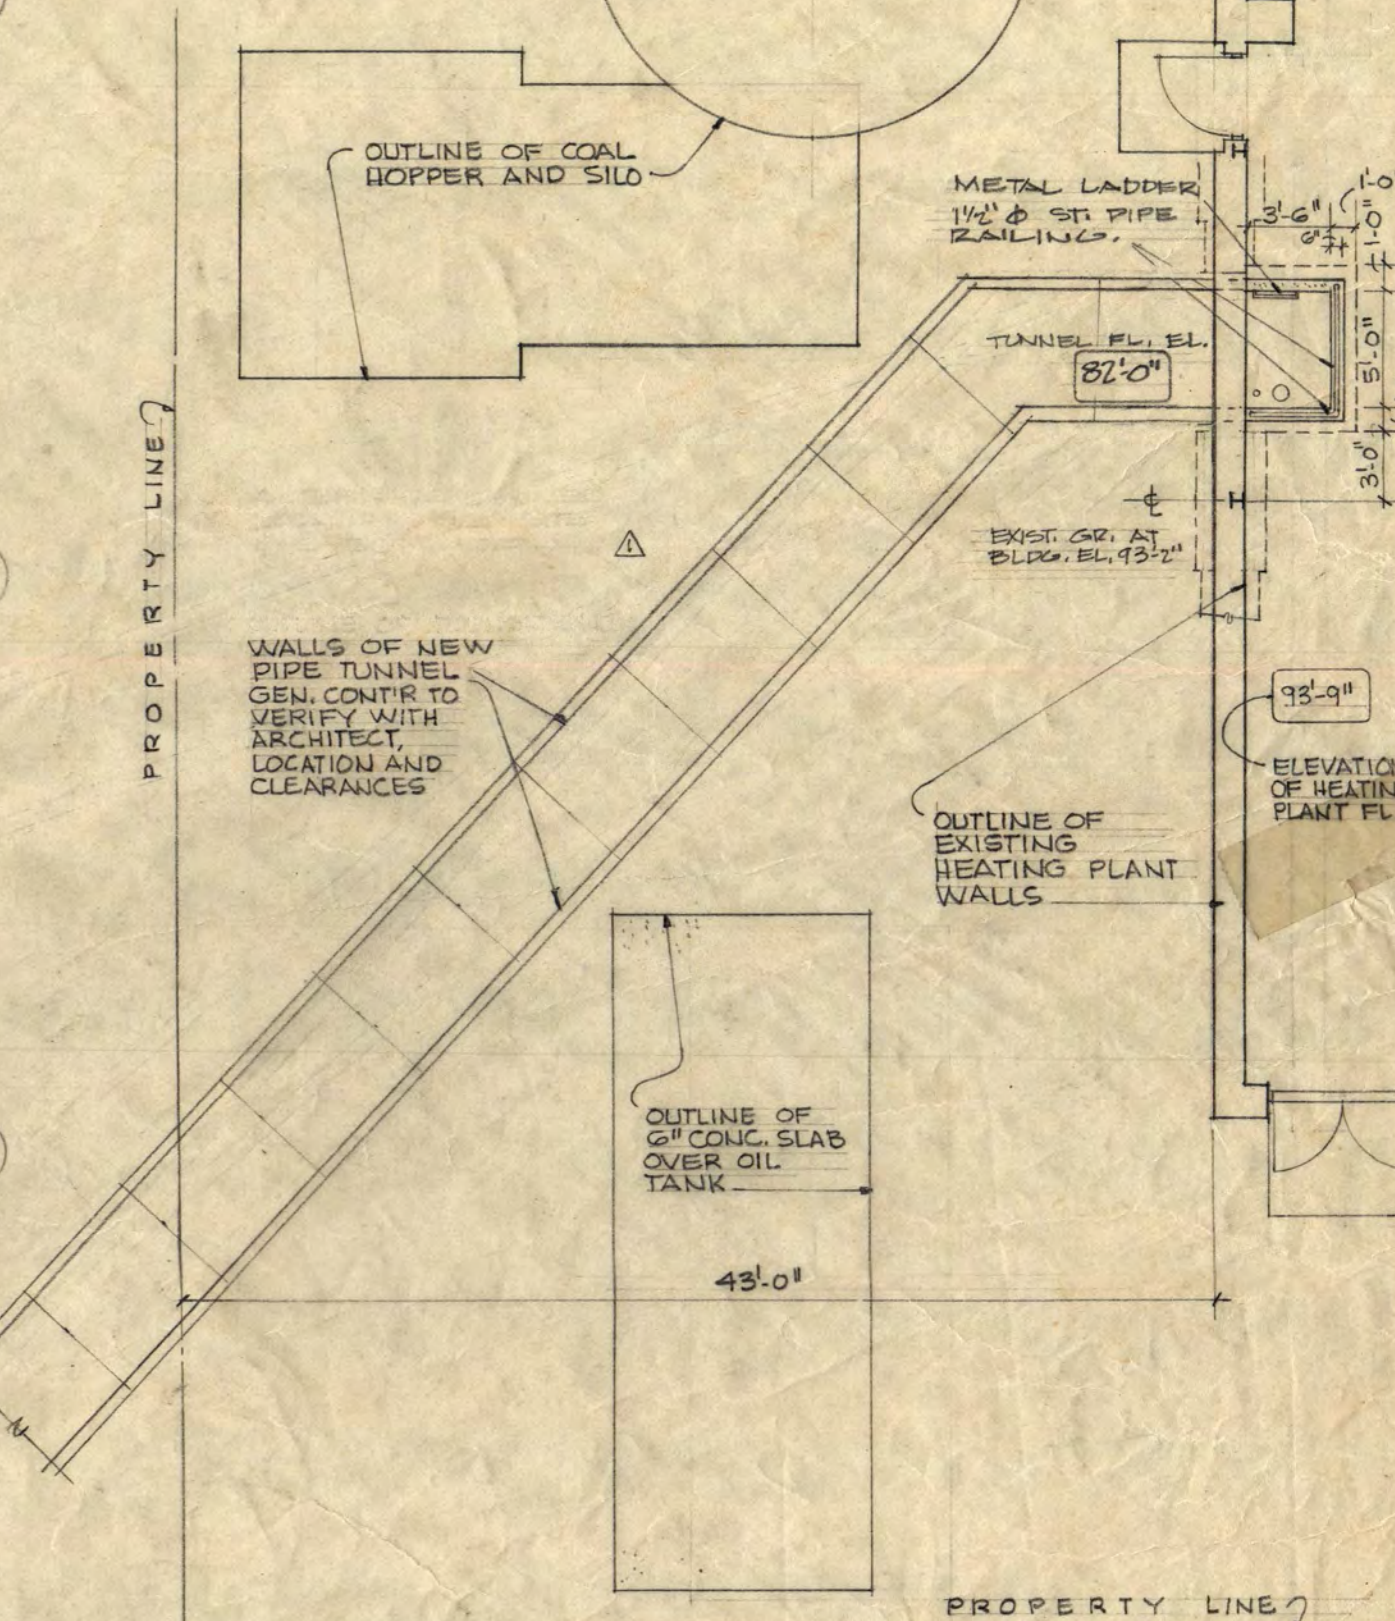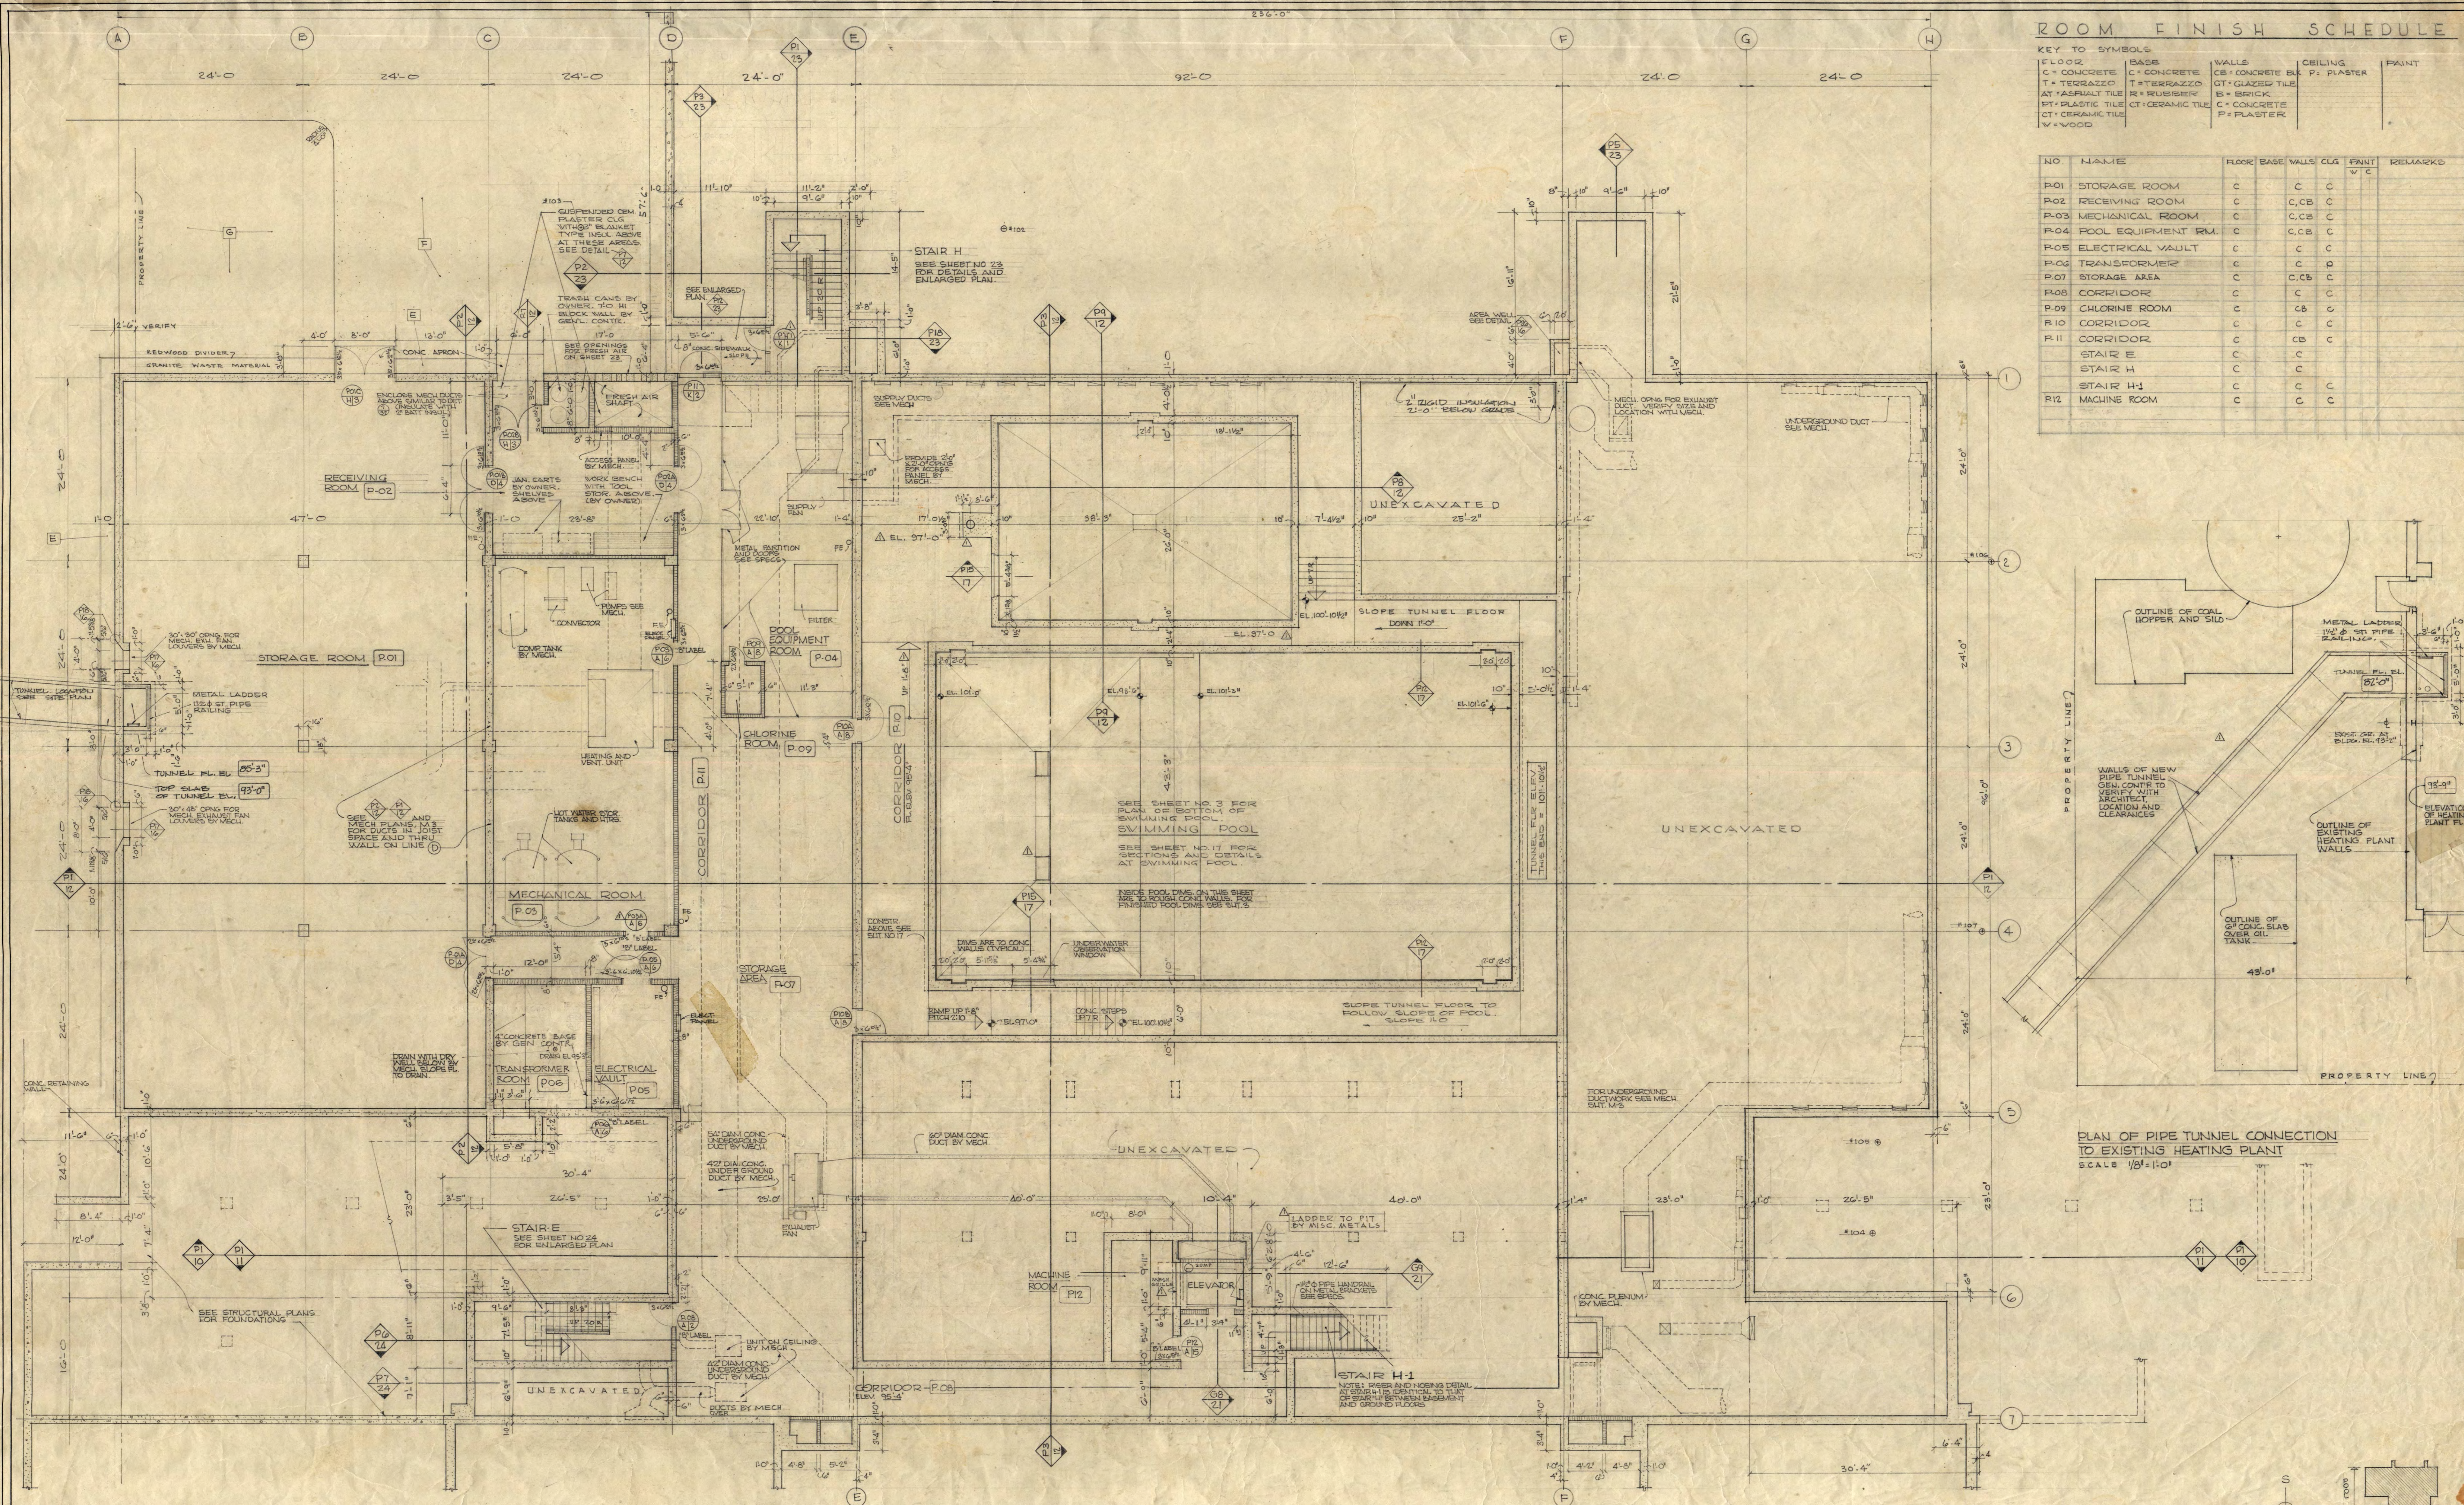

PLAN OF PIPE TUNNEL CONNECTION TO EXISTING HEATING PLANT
SCALE 1/8" = 1'-0"

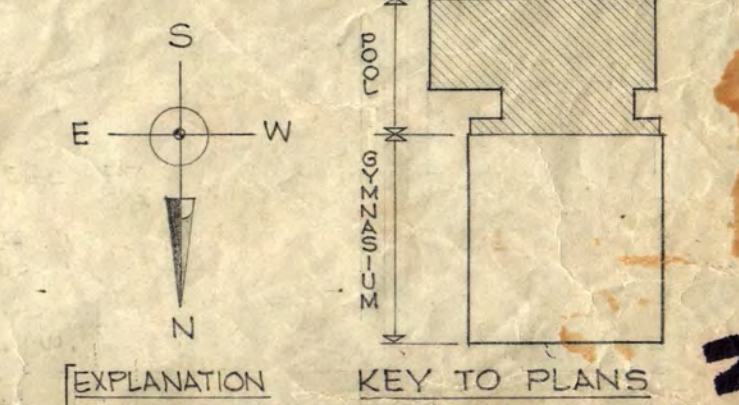

INSTRUCTIONAL BUILDING FOR PHYSICAL EDUCATION
ST. CLOUD STATE COLLEGE
DEPARTMENT OF ADMINISTRATION
ARCHITECTURAL AND ENGINEERING DIVISION
A. J. NELSON, STATE ARCHITECT

STATE OF MINNESOTA
ST. PAUL, MINNESOTA

APPROVED BY PRESIDENT OF ST. CLOUD STATE COLLEGE
APPROVED BY STATE BOARD OF EDUCATION
APPROVED BY DEPARTMENT OF ADMINISTRATION

BASEMENT PLAN POOL

TRAYNOR AND HERMANSON ARCHITECTS ST. CLOUD
DATE 1-17-63
DRAWN TWS, RAS, TJO

ST. CLOUD, MINNESOTA
PROJECT NUMBER 3425


ROOM FINISH SCHEDULE

KEY TO SYMBOLS:


FLOOR	WALLS	CEILING	PAINT
C- CONCRETE	C- CONCRETE	C- CONCRETE	R- RUBBER
T- TERRAZO	T- TERRAZO	A- ACCIDENTAL TILE	E- ENAMEL
AT- ASPHALT TILE	C- CERAMIC TILE	S- SMOOTH	
PT- PLASTER	CT- CERAMIC TILE	P- PLASTER	
W- WOOD			

NO.	NAME	FLOOR	WALLS	CEILING	PAINT	REMARKS
P-100	STORAGE	C	C	C		
P-101	ENTRY	T	C	C		
P-102	SHOWER ROOM	T	T	CT	C	
P-103	DRYING ROOM	T	T	CT	C	
P-104	TOILET ROOM	T	T	CT	C	
P-105	WOMENS LOCKER RM.	T	T	CT*	C	*SEE ELEV. FOR CT AREA.
P-106	FIRST AID	T	T	CT*	C	*TO 7'-0" HEIGHT
P-107	ISSUE STORAGE	C	C	C		
P-108	STORAGE	C	C	C		
P-109	CORRIDOR	T	T	CT	C	
P-110	CORRIDOR	T	T	CT	C	
P-111	CORRIDOR	T	T	CT	C	
P-112	POOL OFFICE	T	T	CT	P	*SUSPENDED
P-113	STORAGE	C	C	C		
P-114	ISSUE STORAGE	C	C	C		
P-115	INTRA-PHY-ED ISSUE	C	C	C		
P-116	VARSITY ISSUE	C	C	C		
P-117	ISSUE	C	C	C		
P-118	HALL	T	T	CT	C	
P-119	ISSUE AREA	T	T	CT	C	
P-120	HYDRO THERAPY	T	T	CT*	C	*TO 7'-0" HEIGHT
P-121	TRAINING ROOM	T	T	CT*	C	*TO 7'-0" HEIGHT
P-122	TOILET ROOM	T	T	CT*	C	*CT TO 7'-0" IN WALL
P-123	SHOWER ROOM	T	T	CT	C	
P-124	DRYING ROOM	T	T	CT	C	
P-125	STORAGE	C	C	C		
P-126	ENTRY	T	T	CT	C	
P-127	MENS LOCKER ROOM	T	T	CT*	C	*SEE ELEV. FOR CT AREAS.
P-128	TEAM ROOM	T	T	CT	C	
P-129	SHOWER ROOM	T	T	CT	C	
P-130	DRYING ROOM	T	T	CT	C	
P-131	TEAM ROOM	T	T	CT	C	
P-132	TEAM ROOM	T	T	CT	C	
P-133	TEAM ROOM	T	T	CT	C	
P-134	TEAM ROOM	T	T	CT	C	
P-135	TEAM ROOM	T	T	CT	C	
P-136	SHOWER ROOM	T	T	CT	C	
P-137	SHOWER ROOM	T	T	CT	C	
P-138	TEAM ROOM	T	T	CT	C	
P-139	SWIMMING POOL	CT	CT	CT	C	*LOW CONC. SLAB. CT TO 7'-0". SEE DET.
	STAIR E	T	T	CT	C	
	STAIR F	T	T	CT	C	
	STAIR G	C	C	CT	C	
	STAIR H	C	C	CT	C	
	STAIR H-1	C	C	CT	C	

GENERAL NOTES:
 ALL PLAN DIMENSIONS TO WALLS AND WALL THICKNESSES ARE NOMINAL DIMENSIONS AND DO NOT INCLUDE CERAMIC TILE OR PLASTER THICKNESSES. AT ALL-T-HIGH MASONRY WALLS THE WALLS ARE TO BE REINFORCED WITH #4 BARS @ 6" O.C. DOWN INTO THE FLOOR AND THE CORNERS TO BE FILLED.
 MASONRY CORNER SHALL BE RECESSED JOINT TO TOP OF BLOCK WALL AT JAMES OF DOORS POOL P-125 AND P-126. RESULTING PANEL ABOVE DOORS SHALL BE PAINTED.
 GENERAL CONTR. TO PROVIDE LINTEL BLOCK OVER SPRINGS AS REQUIRED FOR DUCTS THRU WALLS AND DOORS. #4'S TOP AND BY SEE SHEET 16 FOR TYPICAL PIPE CHASE DETAILS.
 LOCKER BENCH NOTE: ALL LOCKER BENCHES BY OWNER. *ADDED BY SUPPLEMENTAL AGREEMENT.

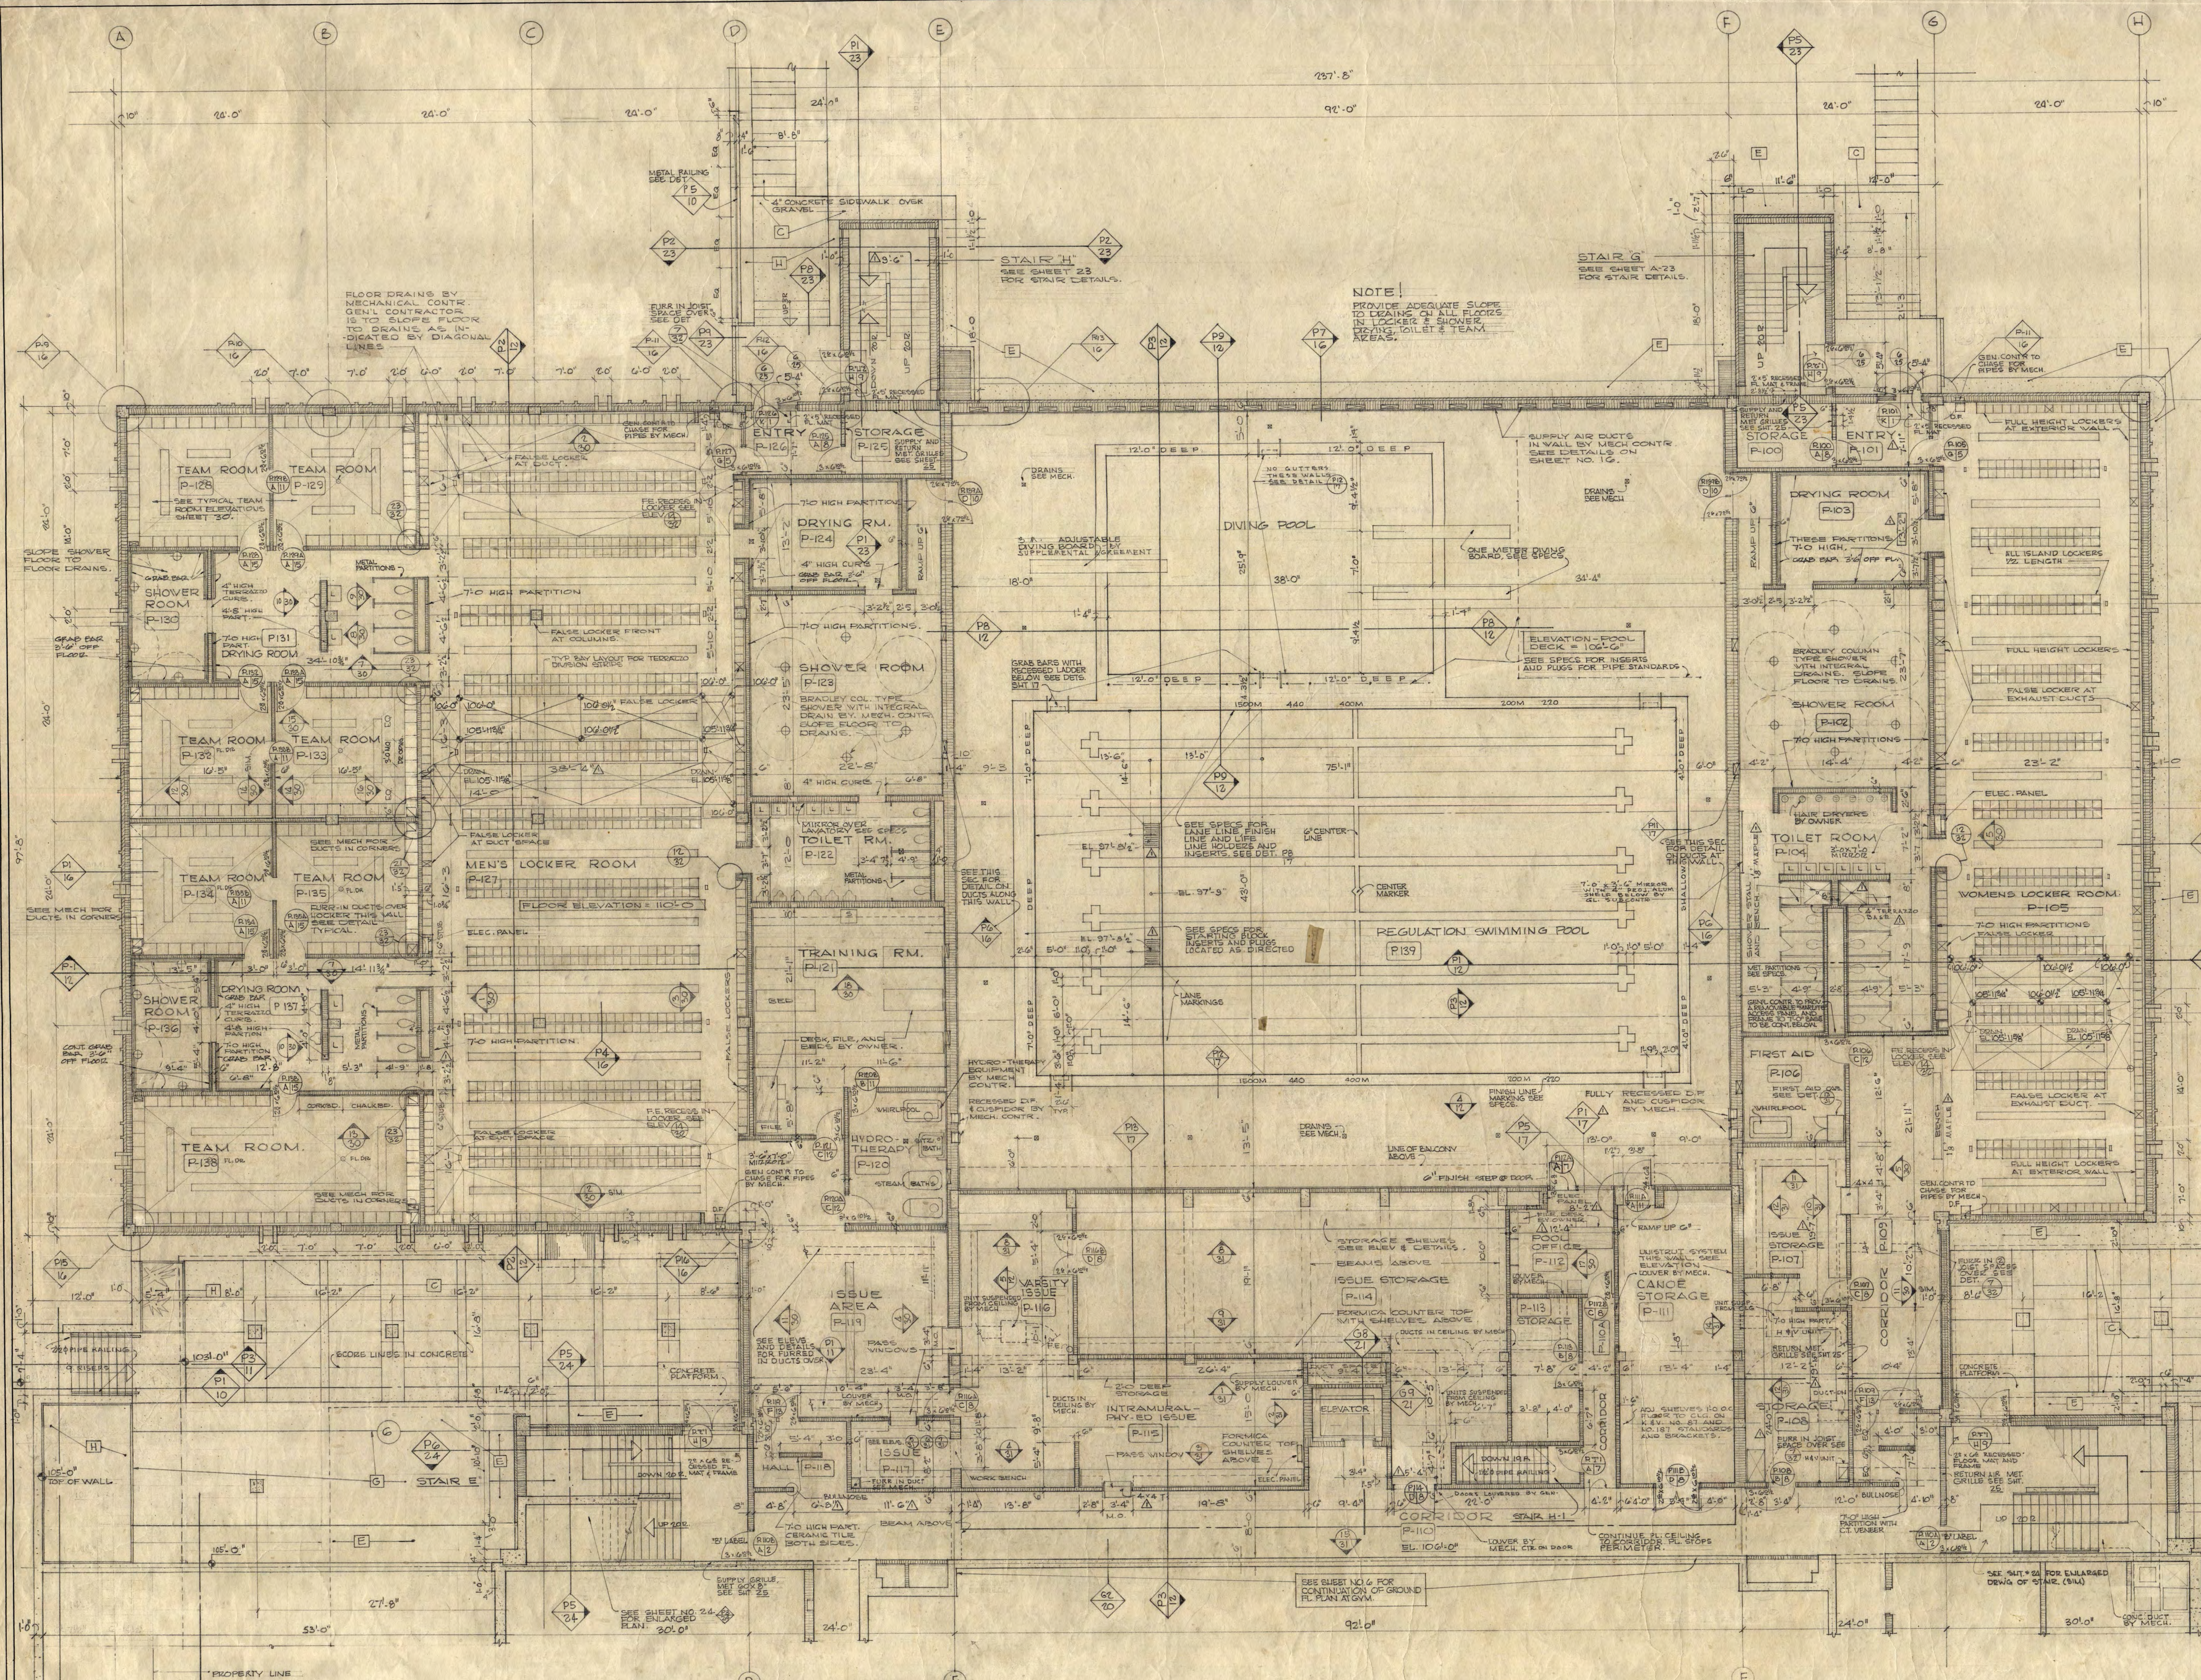

GROUND FLOOR PLAN AT POOL WING.
 1/8" = 1'-0"

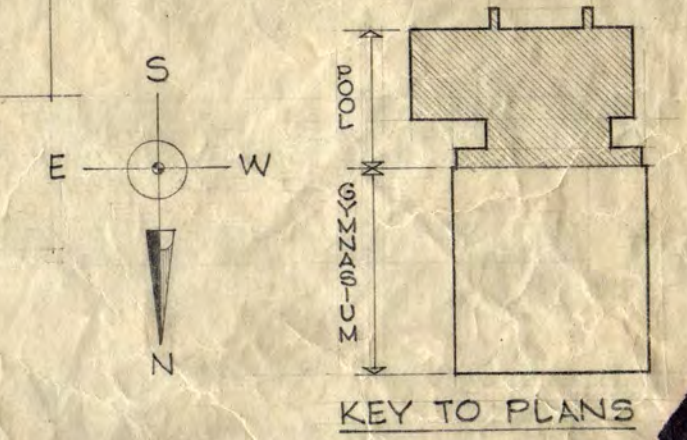


INSTRUCTIONAL BUILDING FOR PHYSICAL EDUCATION
 ST. CLOUD STATE COLLEGE ST. CLOUD, MINNESOTA
 DEPARTMENT OF ADMINISTRATION STATE OF MINNESOTA
 ARCHITECTURAL AND ENGINEERING DIVISION
 A.J. NELSON, STATE ARCHITECT
 APPROVED BY PRESIDENT OF STATE COLLEGE
 APPROVED BY STATE COLLEGE BOARD
 APPROVED BY COMMISSIONER OF ADMINISTRATION
 TRAYNOR AND HERMANSON ARCHITECTS, ST. CLOUD
 DATE 1-17-55
 DRAWING NO. 10, RAS
 3425

ROOM FINISH SCHEDULE


FLOOR	BASE	WALLS	CEILING	PAINT
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T = TERRAZZO	T = TERRAZZO	GT = GROUTED TILE	C = CONCRETE	E = ENAMEL
AT = ASPHALT TILE	GT = GROUTED TILE	B = BRICK		
PT = PLASTIC TILE	GT = GROUTED TILE	C = CONCRETE		
ST = GAMING TILE	GT = GROUTED TILE	P = PLASTER		
W = WOOD				

NO.	NAME	FLOOR	BASE	WALLS	CEILING	PAINT	REMARKS
P-200	ENTRY	T	T	CB	P	R	GLASS CEILING TO LINE
P-201	ENTRY	T	T	CB	P	R	GLASS CEILING TO LINE
P-202	CORRIDOR	T	T	CB	C	R	GLASS CEILING FROM LINE TO 7'0" HGT.
P-203	CORRIDOR	PT	R	CB	C	R	
P-204	CORRIDOR	T	T	CB	C	R	
P-205	CORRIDOR	PT	R	CB	C	R	
P-206	CORRIDOR	PT	R	CB	C	R	
P-207	CORRIDOR	PT	R	CB	C	R	
P-208	CLASSROOM	AT	R	CB	C	R	
P-209	CLASSROOM	AT	R	CB	C	R	
P-210	CLASSROOM	AT	R	CB	C	R	
P-211	CLASSROOM	AT	R	CB	C	R	
P-212	STORAGE	C	C	CB	C	R	
P-213	JANITOR	C	C	CB	C	R	
P-214	WOMEN'S TOILET	T	T	CT	P	R	
P-215	POOL BALCONY	C	C	C	C	R	
P-216	MEN'S TOILET	T	T	CT	P	R	
P-217	TYPICAL OFFICE	AT	R	CB	C	R	PAINT PLASTER WALLS (ENAMEL)
P-218	CONFERENCE ROOM	AT	R	CB	C	R	
P-219	OFFICE	AT	R	CB	C	R	
P-220	GENERAL OFFICE	AT	R	CB	C	R	
P-221	SEMINAR	AT	R	CB	C	R	
P-222	MECHANICAL ROOM	C	C	CB	C	R	
P-223	CONFERENCE ROOM	AT	R	CB	C	R	
P-224	CONFERENCE ROOM	AT	R	CB	C	R	
P-225	CONFERENCE ROOM	AT	R	CB	C	R	
P-226	CONFERENCE ROOM	AT	R	CB	C	R	
P-227	CONFERENCE ROOM	AT	R	CB	C	R	
P-228	CONFERENCE ROOM	AT	R	CB	C	R	
P-229	CONFERENCE ROOM	AT	R	CB	C	R	
P-230	CONFERENCE ROOM	AT	R	CB	C	R	
P-231	CONFERENCE ROOM	AT	R	CB	C	R	
P-232	CONFERENCE ROOM	AT	R	CB	C	R	
P-233	CONFERENCE ROOM	AT	R	CB	C	R	
P-234	CONFERENCE ROOM	AT	R	CB	C	R	
P-235	CONFERENCE ROOM	AT	R	CB	C	R	
P-236	CONFERENCE ROOM	AT	R	CB	C	R	
P-237	CONFERENCE ROOM	AT	R	CB	C	R	
P-238	CONFERENCE ROOM	AT	R	CB	C	R	
P-239	CONFERENCE ROOM	AT	R	CB	C	R	
P-240	CONFERENCE ROOM	AT	R	CB	C	R	
P-241	CONFERENCE ROOM	AT	R	CB	C	R	
P-242	CONFERENCE ROOM	AT	R	CB	C	R	
P-243	CONFERENCE ROOM	AT	R	CB	C	R	
P-244	CONFERENCE ROOM	AT	R	CB	C	R	
P-245	CONFERENCE ROOM	AT	R	CB	C	R	
P-246	CONFERENCE ROOM	AT	R	CB	C	R	
P-247	CONFERENCE ROOM	AT	R	CB	C	R	
P-248	CONFERENCE ROOM	AT	R	CB	C	R	
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P-252	CONFERENCE ROOM	AT	R	CB	C	R	
P-253	CONFERENCE ROOM	AT	R	CB	C	R	
P-254	CONFERENCE ROOM	AT	R	CB	C	R	
P-255	CONFERENCE ROOM	AT	R	CB	C	R	
P-256	CONFERENCE ROOM	AT	R	CB	C	R	
P-257	CONFERENCE ROOM	AT	R	CB	C	R	
P-258	CONFERENCE ROOM	AT	R	CB	C	R	
P-259	CONFERENCE ROOM	AT	R	CB	C	R	
P-260	CONFERENCE ROOM	AT	R	CB	C	R	
P-261	CONFERENCE ROOM	AT	R	CB	C	R	
P-262	CONFERENCE ROOM	AT	R	CB	C	R	
P-263	CONFERENCE ROOM	AT	R	CB	C	R	
P-264	CONFERENCE ROOM	AT	R	CB	C	R	
P-265	CONFERENCE ROOM	AT	R	CB	C	R	
P-266	CONFERENCE ROOM	AT	R	CB	C	R	
P-267	CONFERENCE ROOM	AT	R	CB	C	R	
P-268	CONFERENCE ROOM	AT	R	CB	C	R	
P-269	CONFERENCE ROOM	AT	R	CB	C	R	
P-270	CONFERENCE ROOM	AT	R	CB	C	R	
P-271	CONFERENCE ROOM	AT	R	CB	C	R	
P-272	CONFERENCE ROOM	AT	R	CB	C	R	
P-273	CONFERENCE ROOM	AT	R	CB	C	R	
P-274	CONFERENCE ROOM	AT	R	CB	C	R	
P-275	CONFERENCE ROOM	AT	R	CB	C	R	
P-276	CONFERENCE ROOM	AT	R	CB	C	R	
P-277	CONFERENCE ROOM	AT	R	CB	C	R	
P-278	CONFERENCE ROOM	AT	R	CB	C	R	
P-279	CONFERENCE ROOM	AT	R	CB	C	R	
P-280	CONFERENCE ROOM	AT	R	CB	C	R	
P-281	CONFERENCE ROOM	AT	R	CB	C	R	
P-282	CONFERENCE ROOM	AT	R	CB	C	R	
P-283	CONFERENCE ROOM	AT	R	CB	C	R	
P-284	CONFERENCE ROOM	AT	R	CB	C	R	
P-285	CONFERENCE ROOM	AT	R	CB	C	R	
P-286	CONFERENCE ROOM	AT	R	CB	C	R	
P-287	CONFERENCE ROOM	AT	R	CB	C	R	
P-288	CONFERENCE ROOM	AT	R	CB	C	R	
P-289	CONFERENCE ROOM	AT	R	CB	C	R	
P-290	CONFERENCE ROOM	AT	R	CB	C	R	
P-291	CONFERENCE ROOM	AT	R	CB	C	R	
P-292	CONFERENCE ROOM	AT	R	CB	C	R	
P-293	CONFERENCE ROOM	AT	R	CB	C	R	
P-294	CONFERENCE ROOM	AT	R	CB	C	R	
P-295	CONFERENCE ROOM	AT	R	CB	C	R	
P-296	CONFERENCE ROOM	AT	R	CB	C	R	
P-297	CONFERENCE ROOM	AT	R	CB	C	R	
P-298	CONFERENCE ROOM	AT	R	CB	C	R	
P-299	CONFERENCE ROOM	AT	R	CB	C	R	
P-300	CONFERENCE ROOM	AT	R	CB	C	R	

ALL WALLS IN CORRIDOR P-203 SHALL BE STACK BOLD BLOCK, AND AS NOTED OR SHOWN ON ELEVATIONS.
POOL WALLS ONLY TO BE PAINTED IN CORRIDOR P-202 SEE ELEV. ADDED BY SUPPLEMENTAL AGREEMENT.

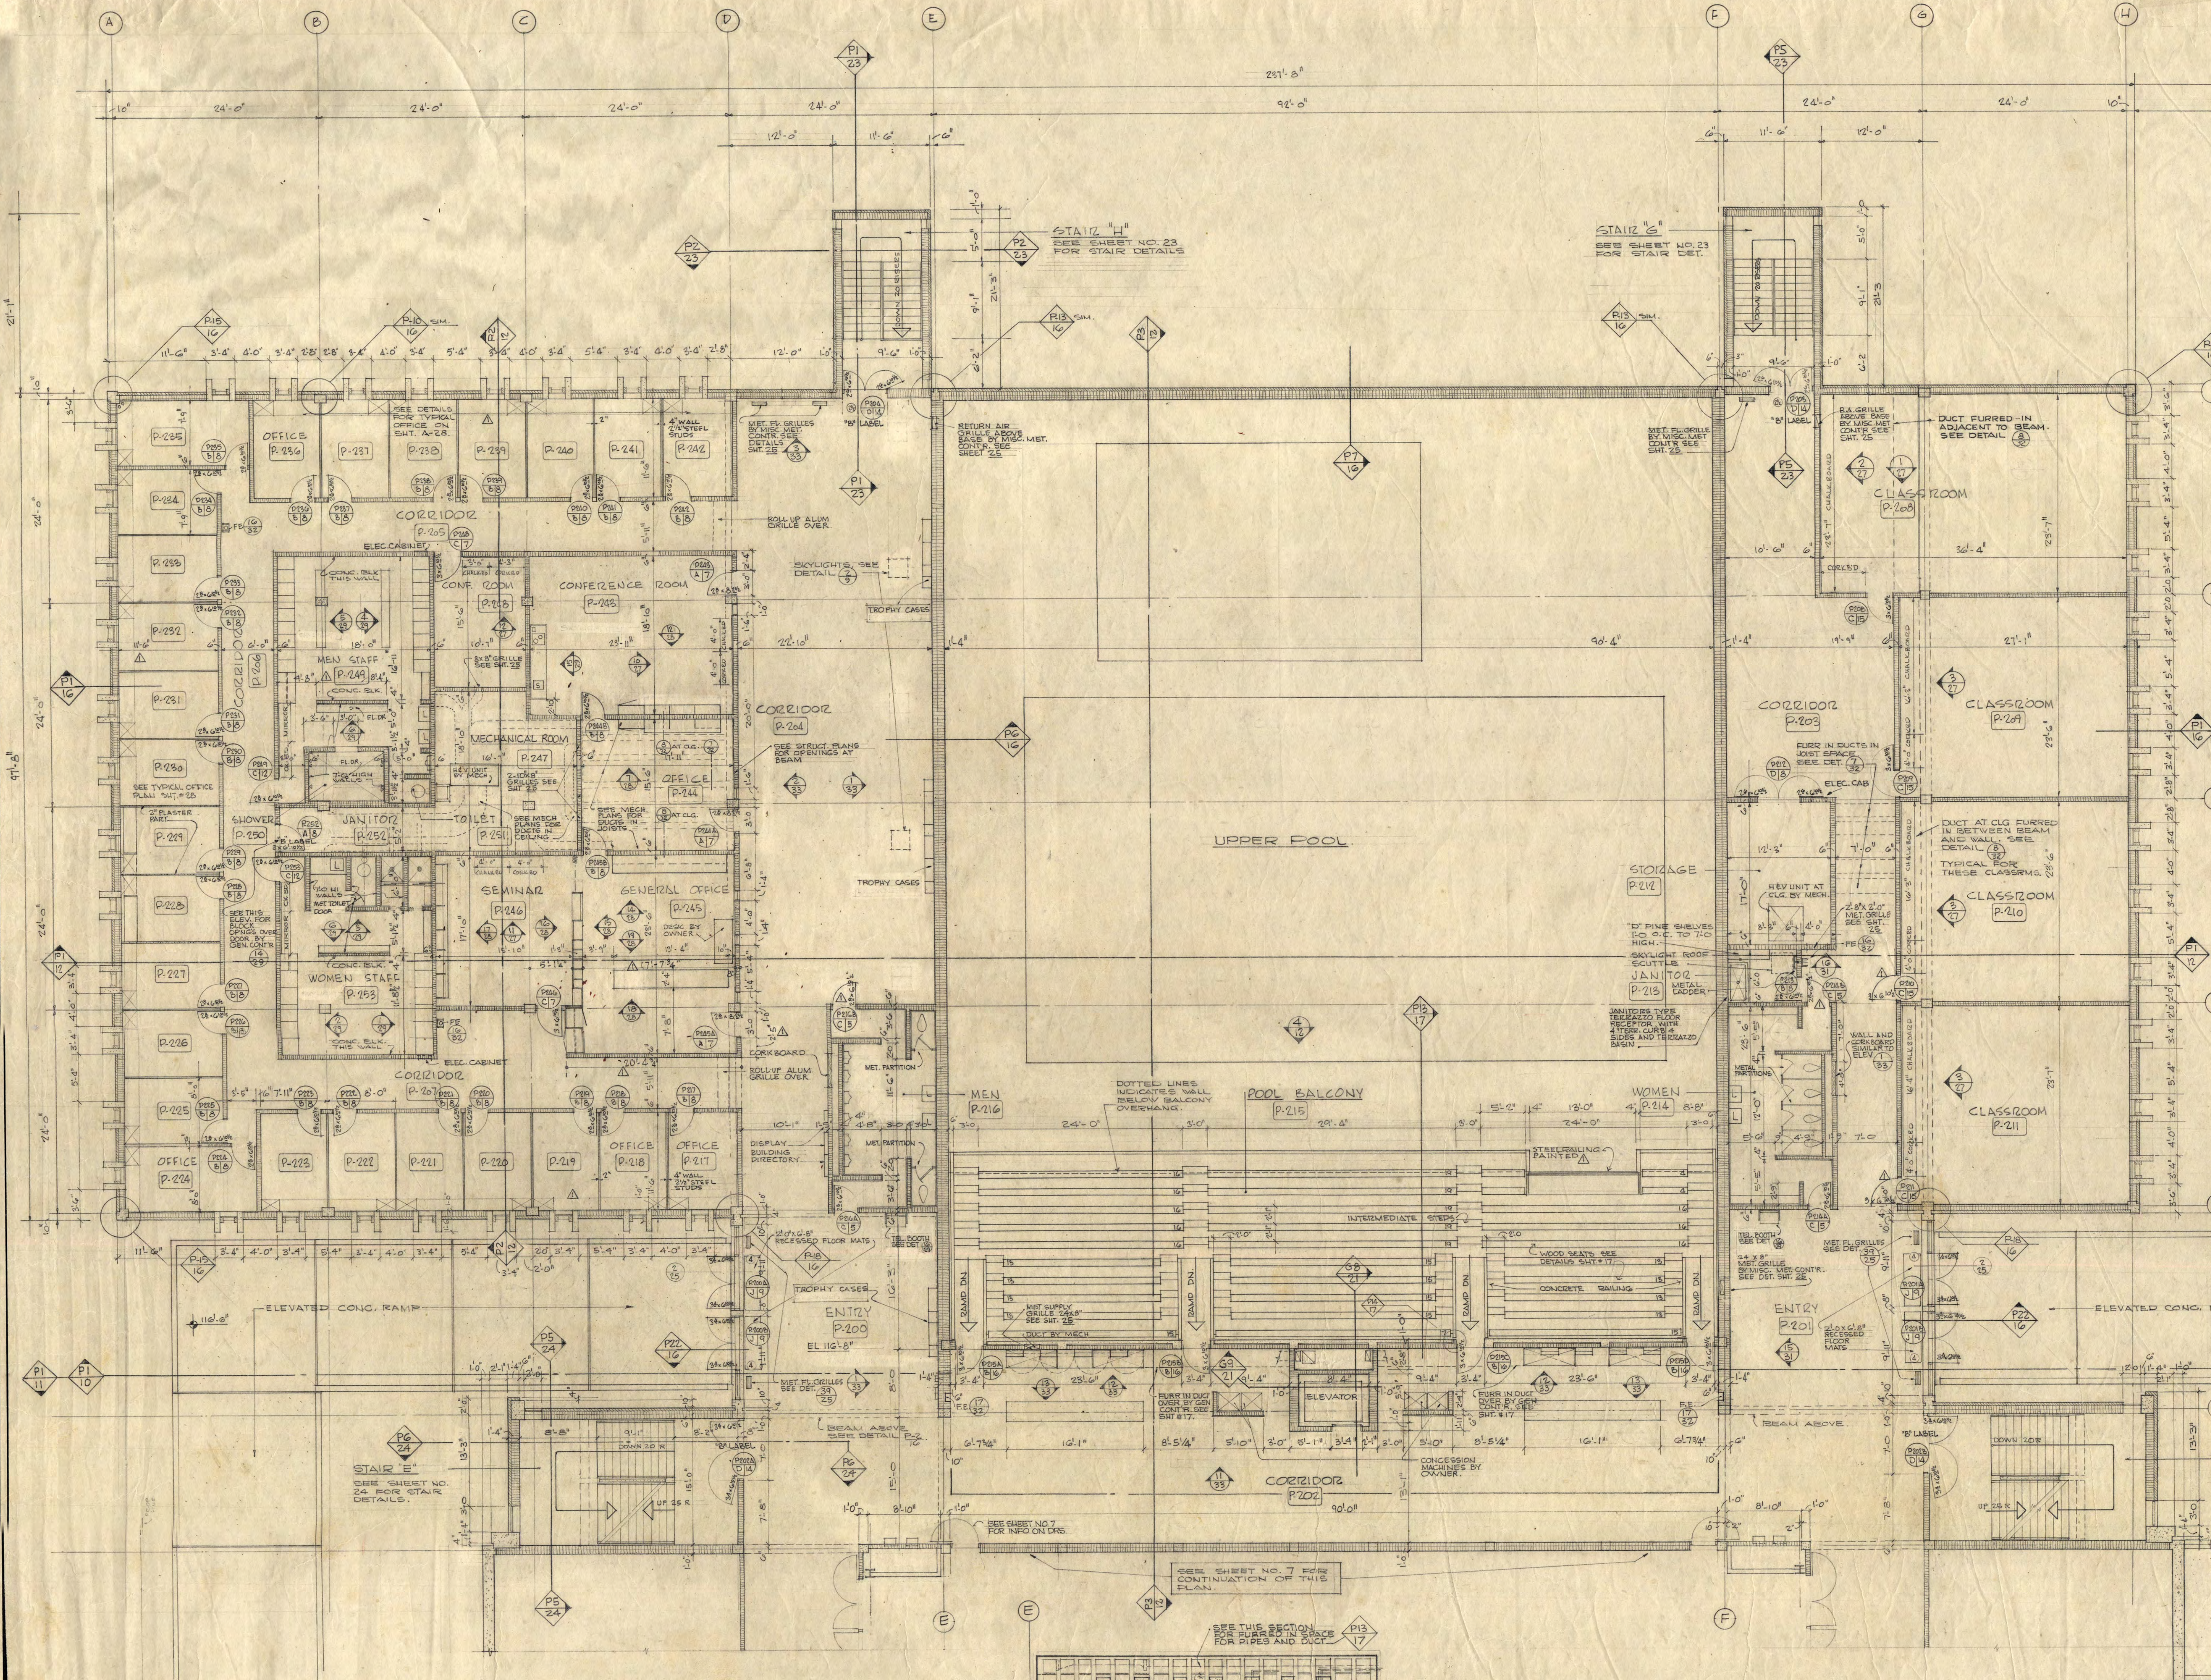

FIRST FLOOR PLAN - POOL WING.
1/8" = 1'-0"

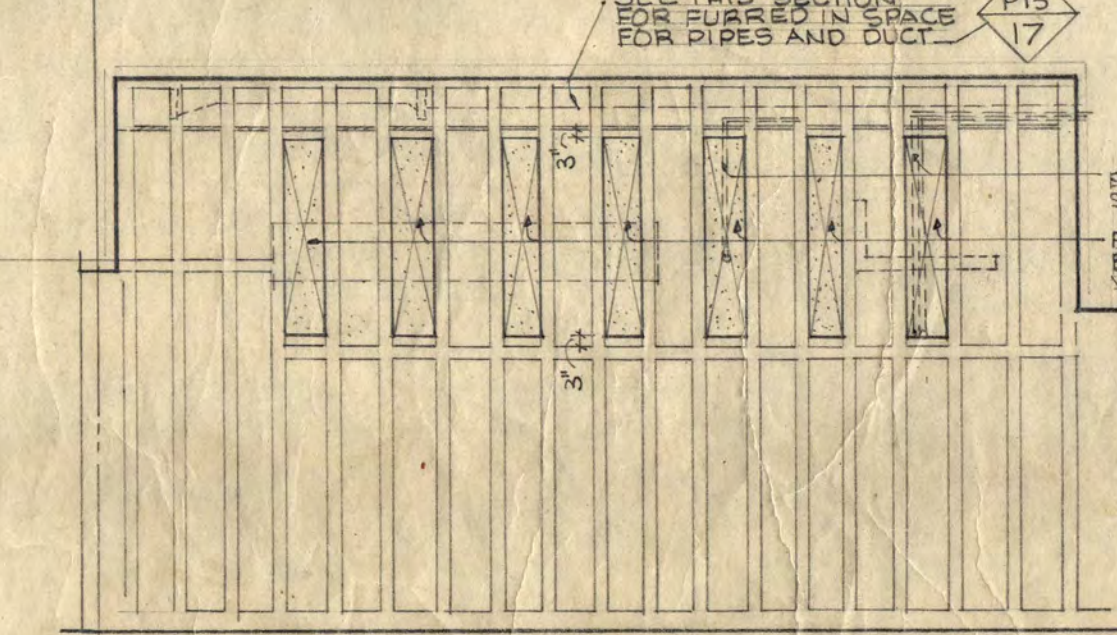

REFLECTED CEILING PLAN OVER CONCESSIONS COUNTER CORRIDOR P-202
SCALE 1/8" = 1'-0"
THIS PLAN SHOWS AREA FROM (E) TO (F) ELEVATOR WALL AND AREA FROM (F) TO (G) ELEVATOR WALL SAME.

INSTRUCTIONAL BUILDING FOR PHYSICAL EDUCATION
ST. CLOUD STATE COLLEGE ST. CLOUD, MINNESOTA
DEPARTMENT OF ADMINISTRATION STATE OF MINNESOTA
ROOM 120 STATE CAPITOL BUILDING ST. PAUL, MINNESOTA
ARCHITECTURAL AND ENGINEERING DIVISION

A. J. NELSON, STATE ARCHITECT
APPROVED BY: [Signature]
APPROVED BY: STATE COLLEGE BOARD
APPROVED BY: [Signature]
APPROVED BY: [Signature]

FIRST FLOOR PLAN POOL
DATE 1-17-62
DRAWN L.H. TVE, T.J.O., P.A.S.
CHECKED [Signature]

KEY TO PLANS 5
4
3425