



ENLARGED DETAIL OF TYPICAL METAL FASCIA & GRAVEL STOP  
SCALE 3/4"=1'-0"




CAPPING DETAIL  
SCALE 3/4"=1'-0"

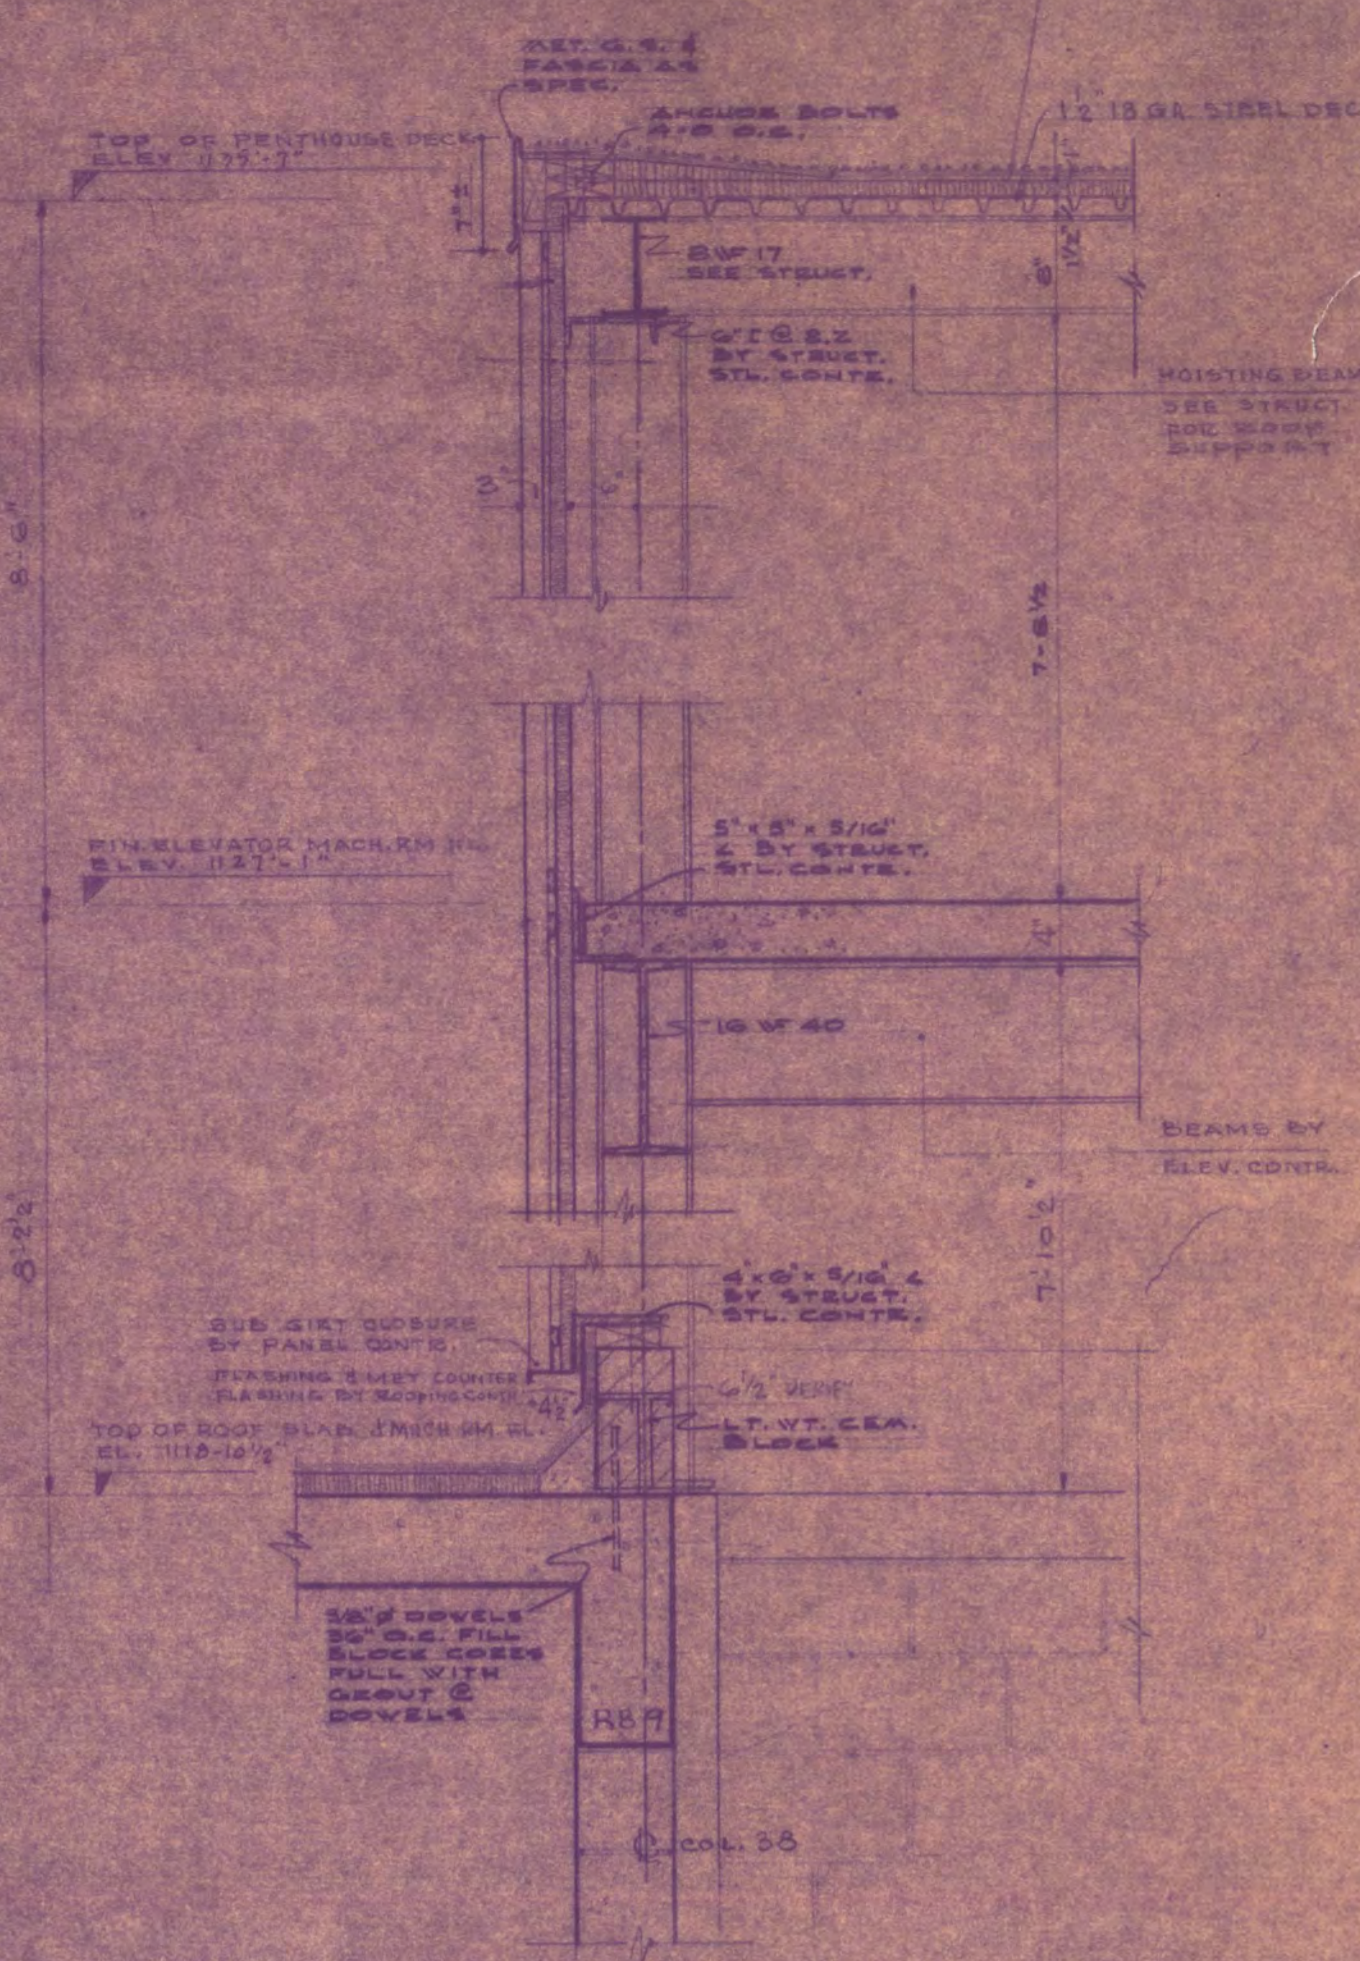


WALL SECTION THRU PENTHOUSE  
SCALE 3/4"=1'-0"

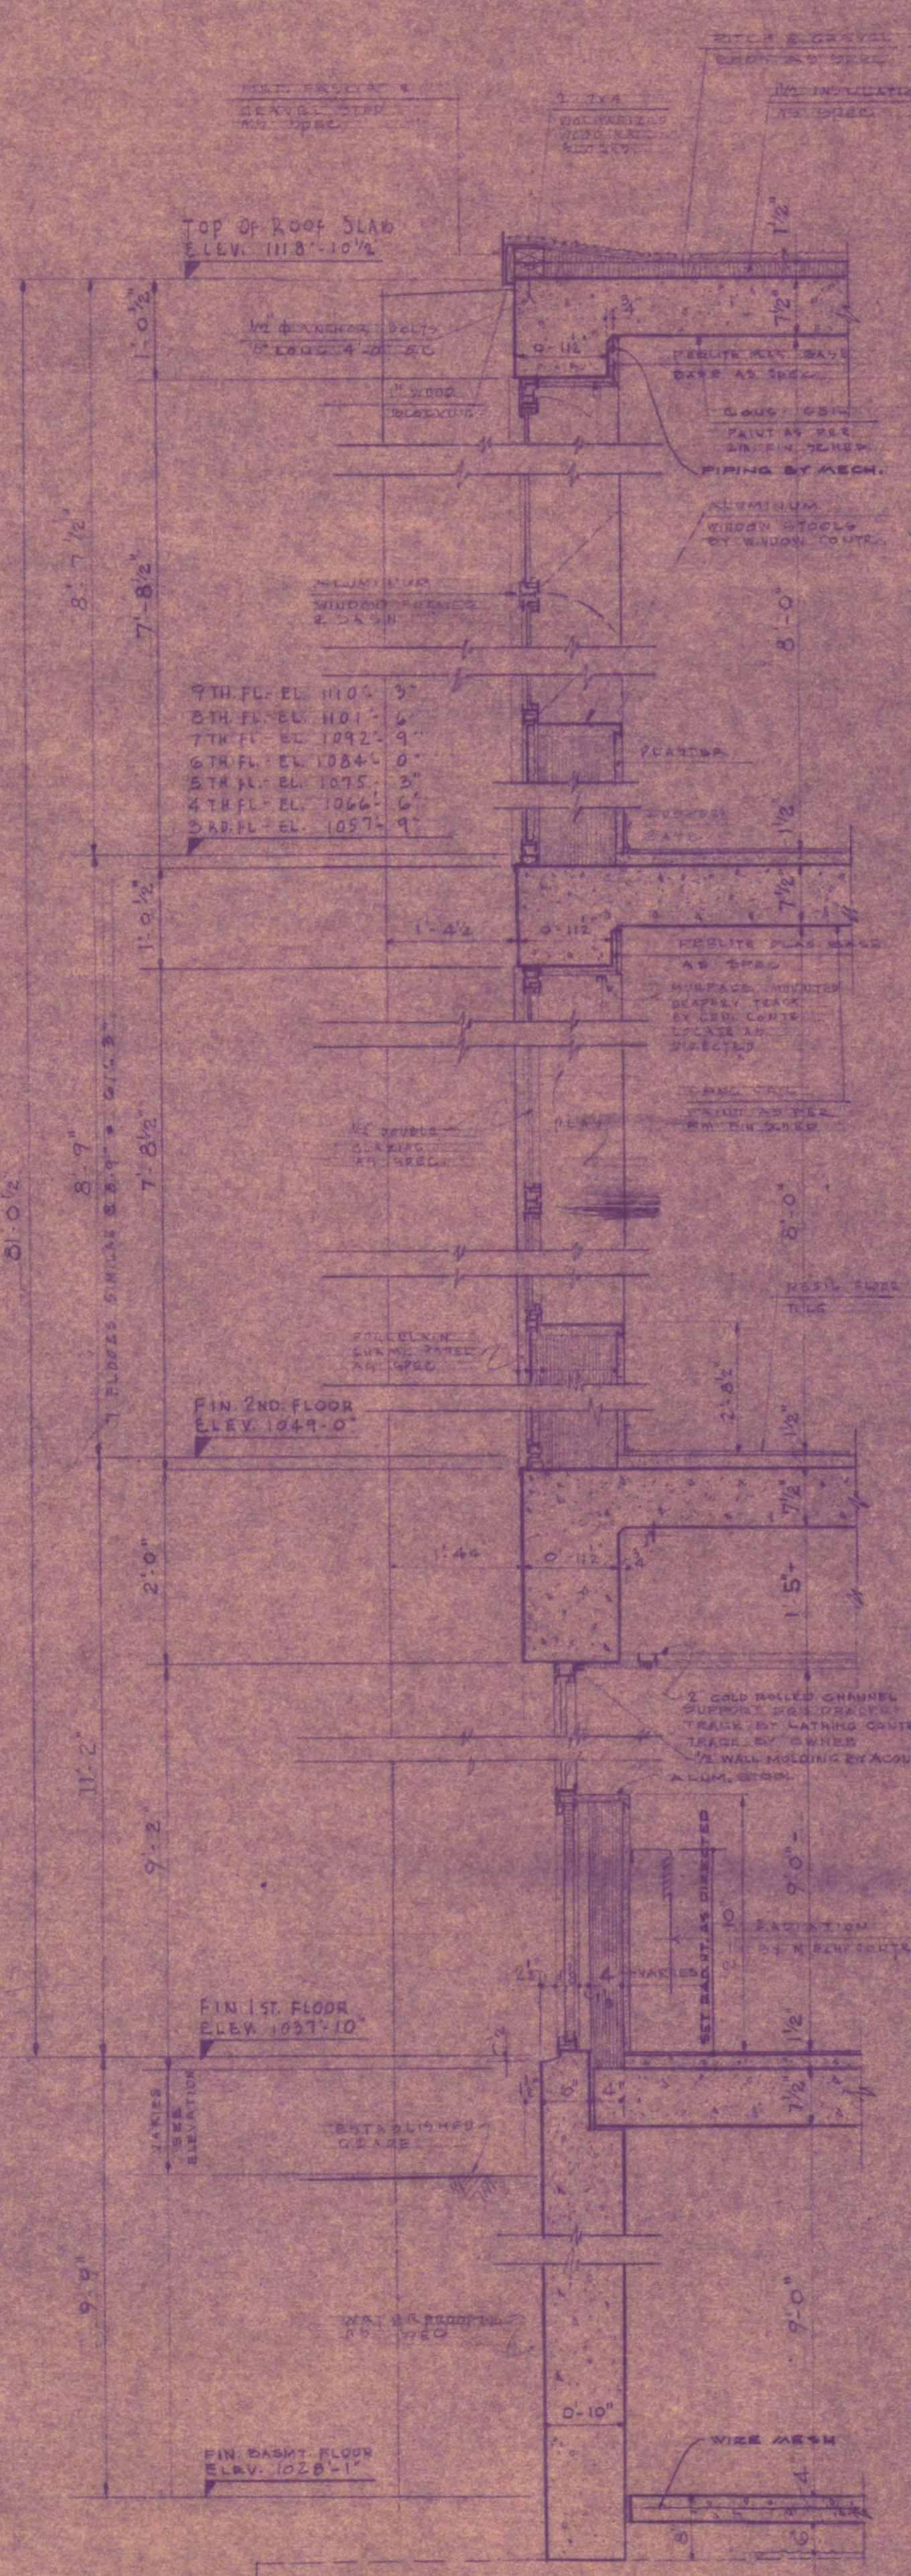


TYPICAL WALL SECTION THRU WINDOWS  
SCALE 3/4"=1'-0"

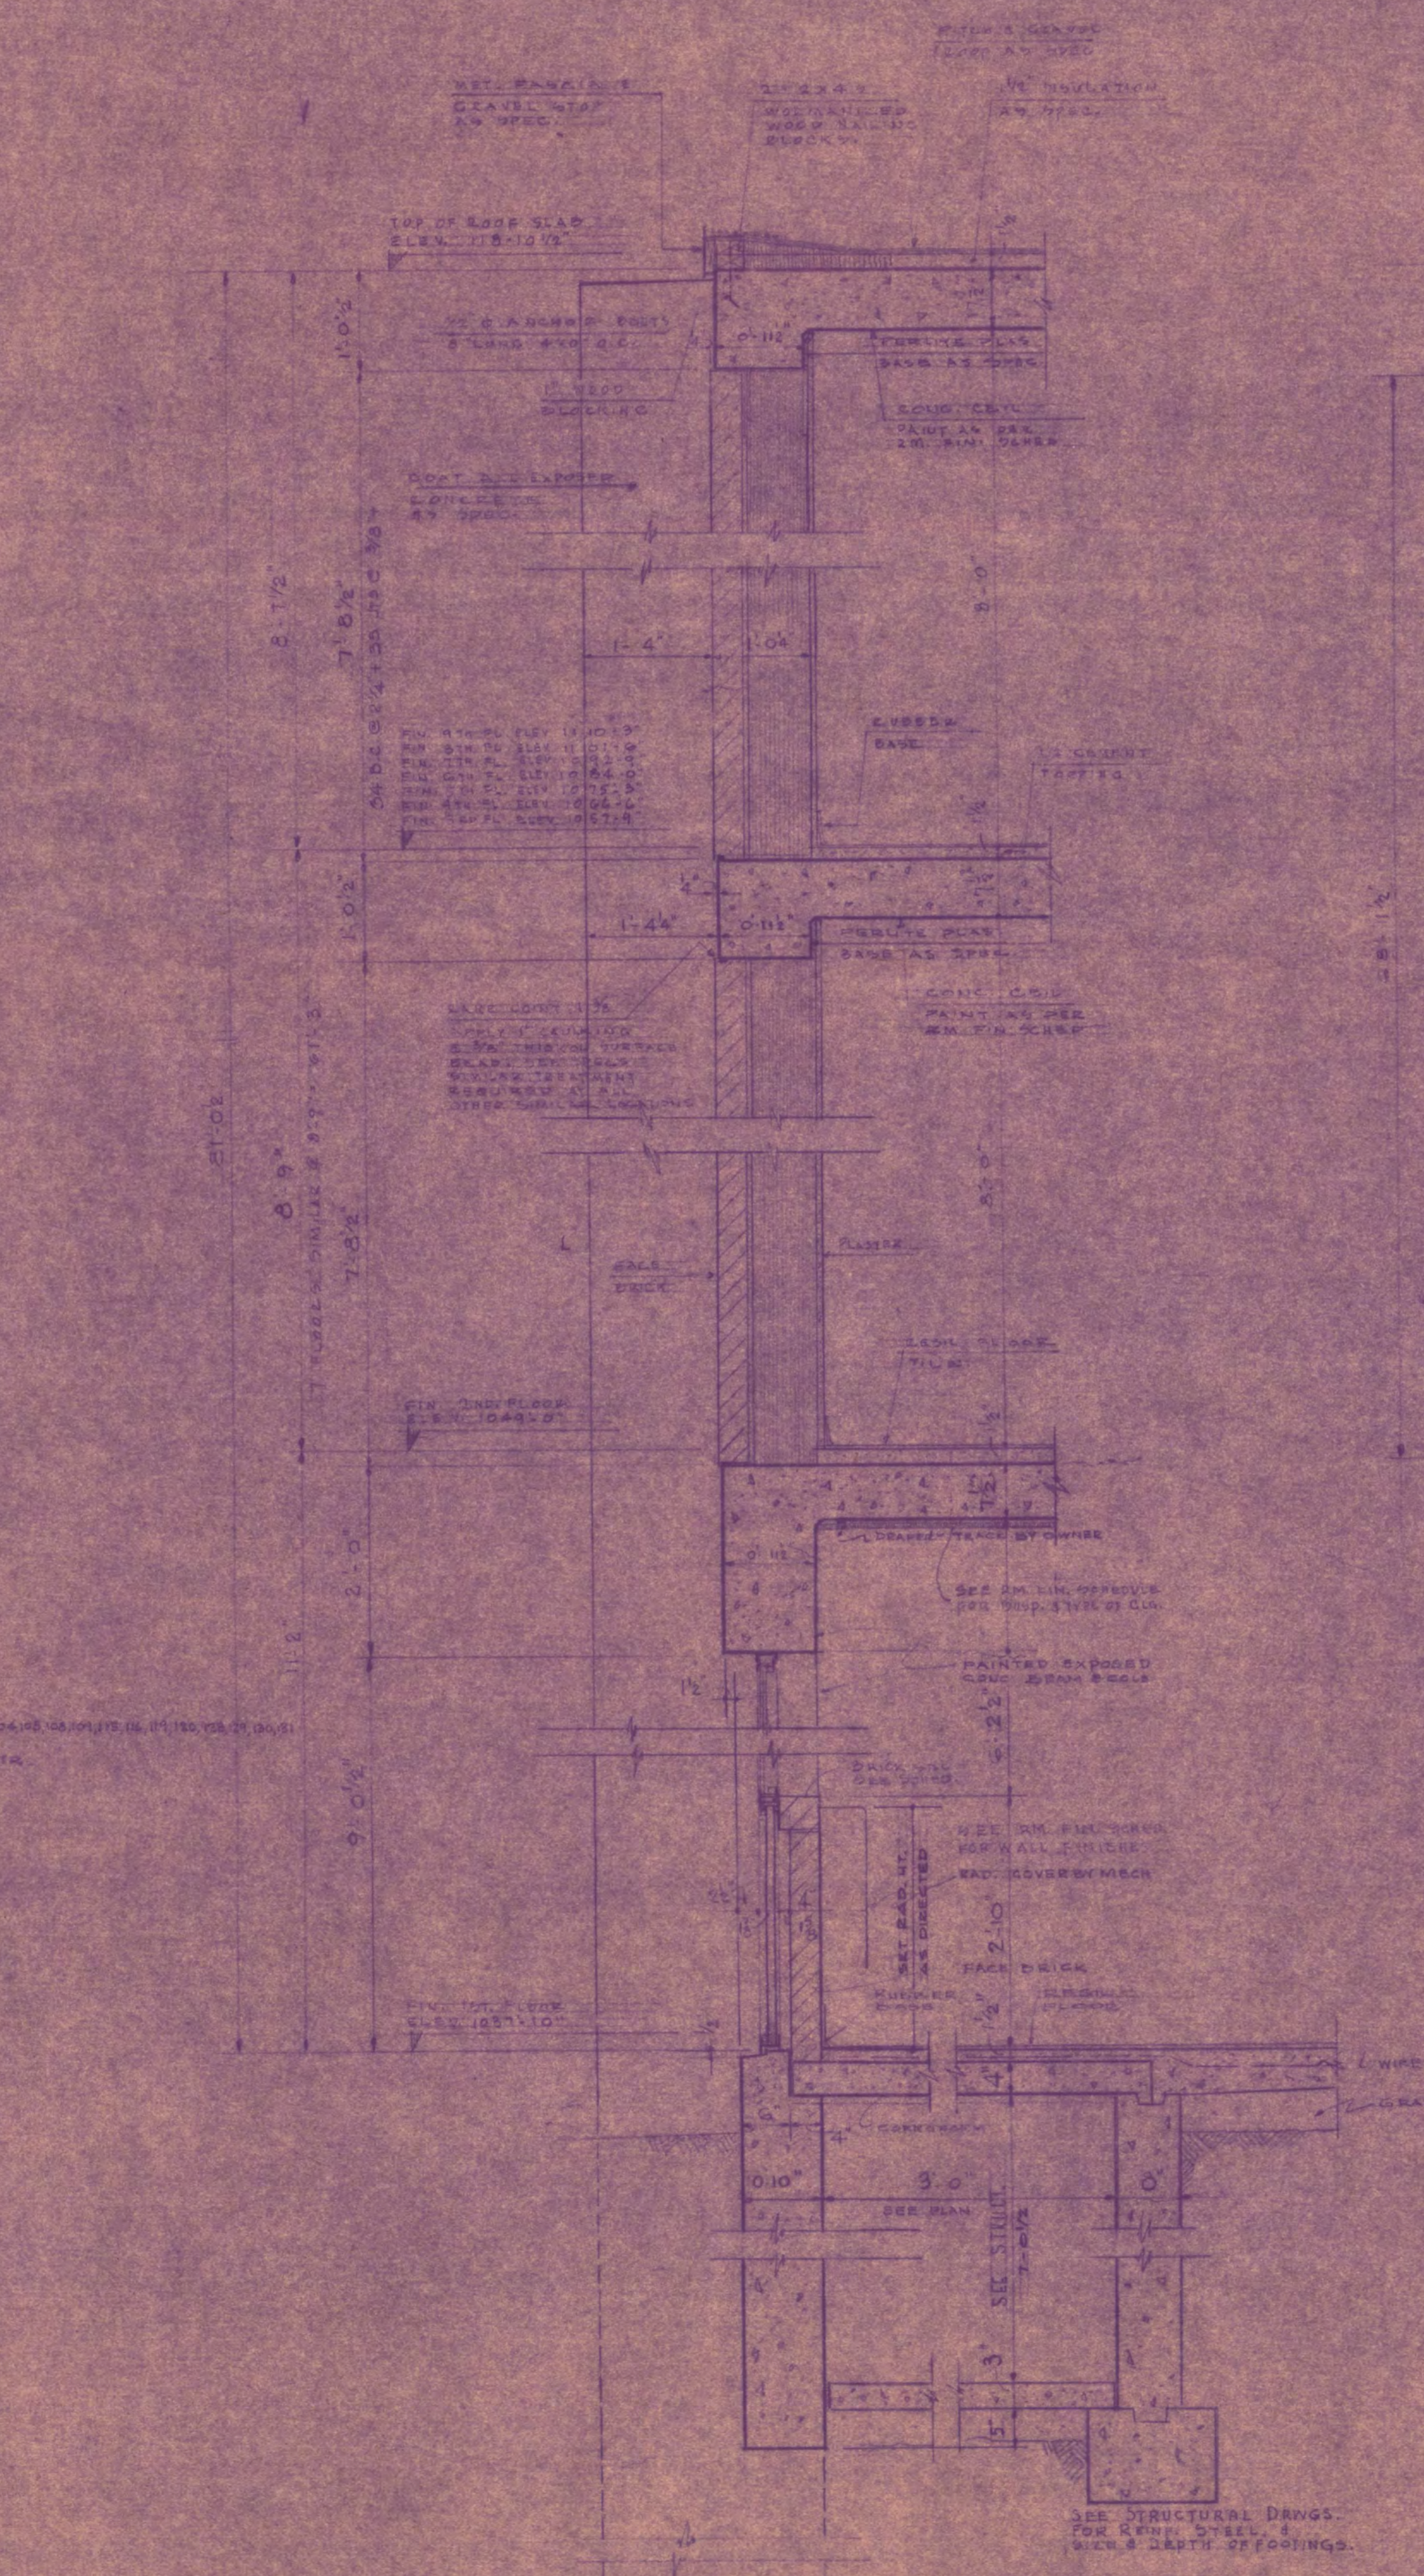


TYPICAL WALL SECT THRU BRICK PIERS  
SCALE 3/4"=1'-0"

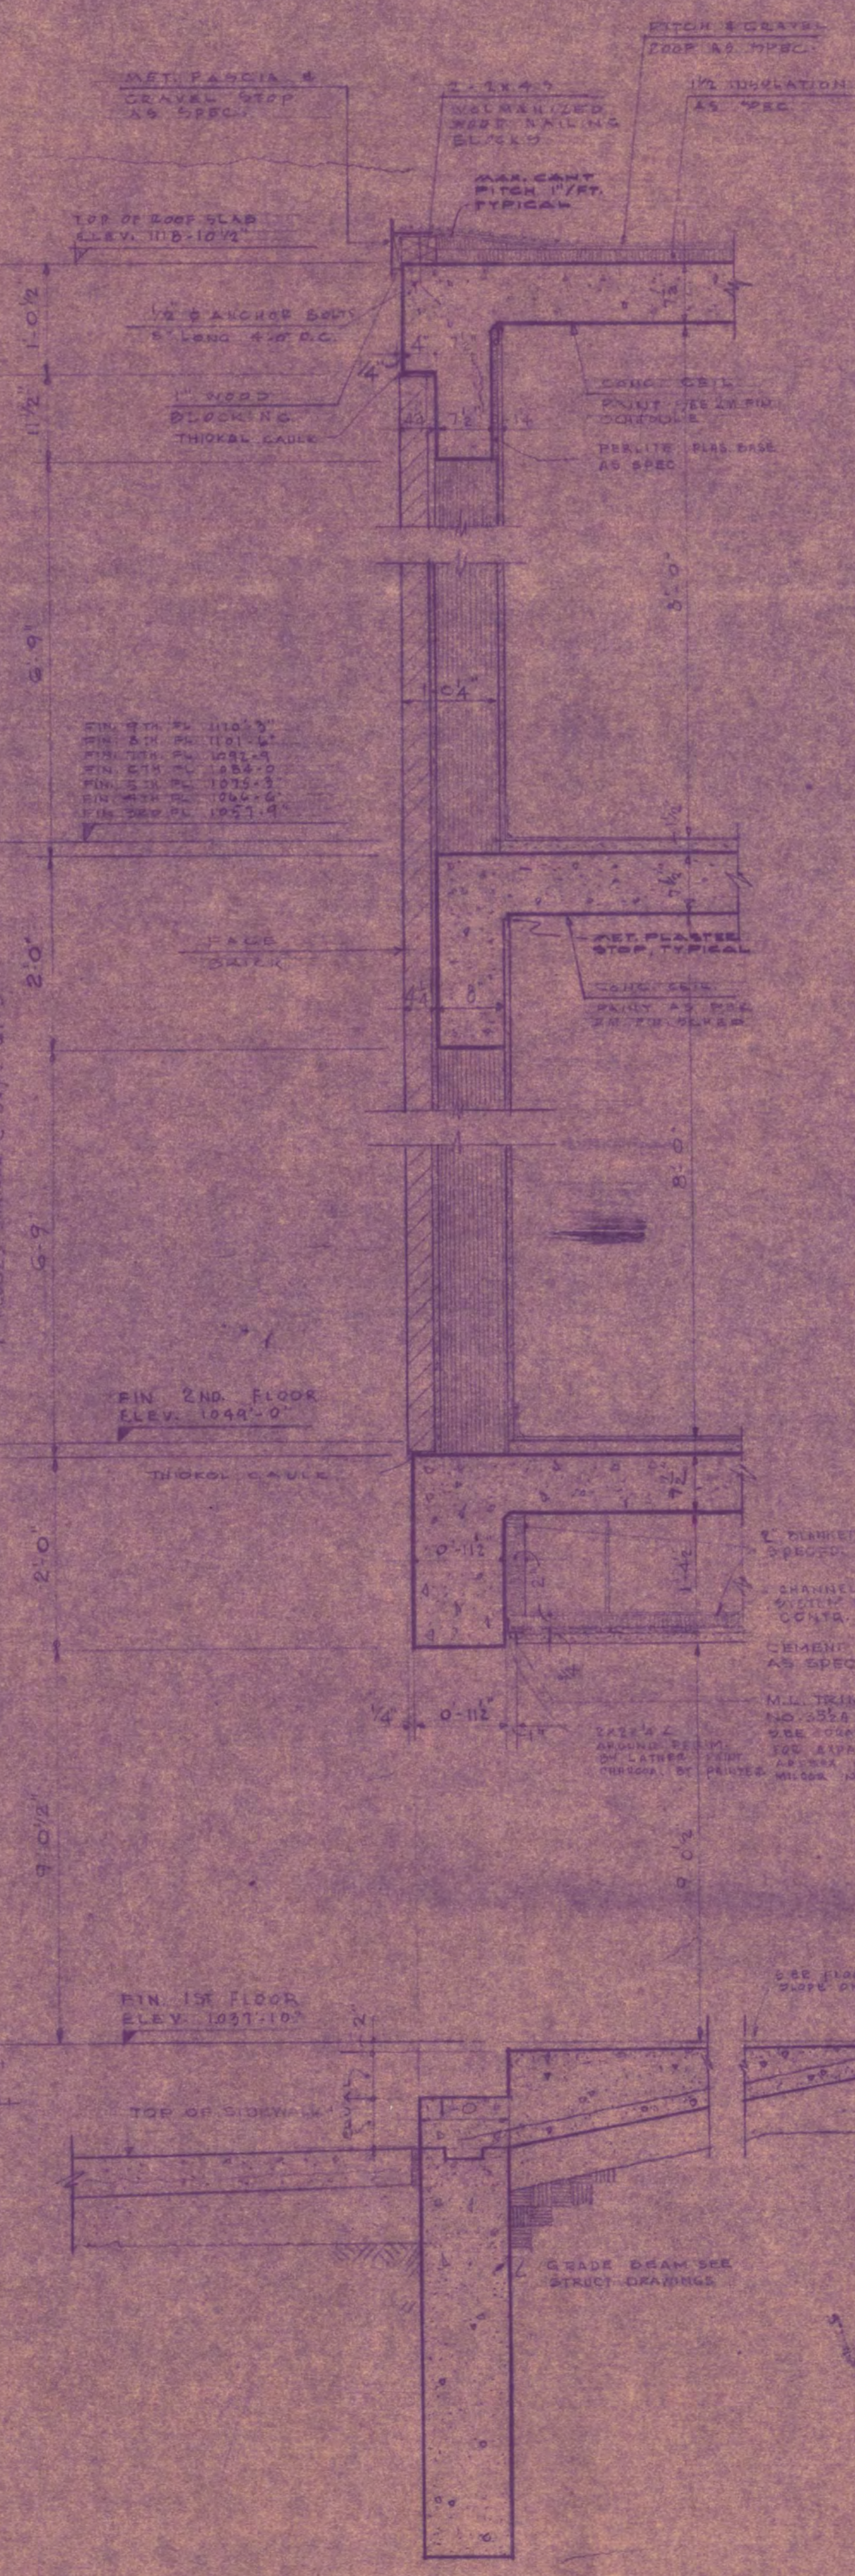


WALL SECTION  
SCALE 3/4"=1'-0"

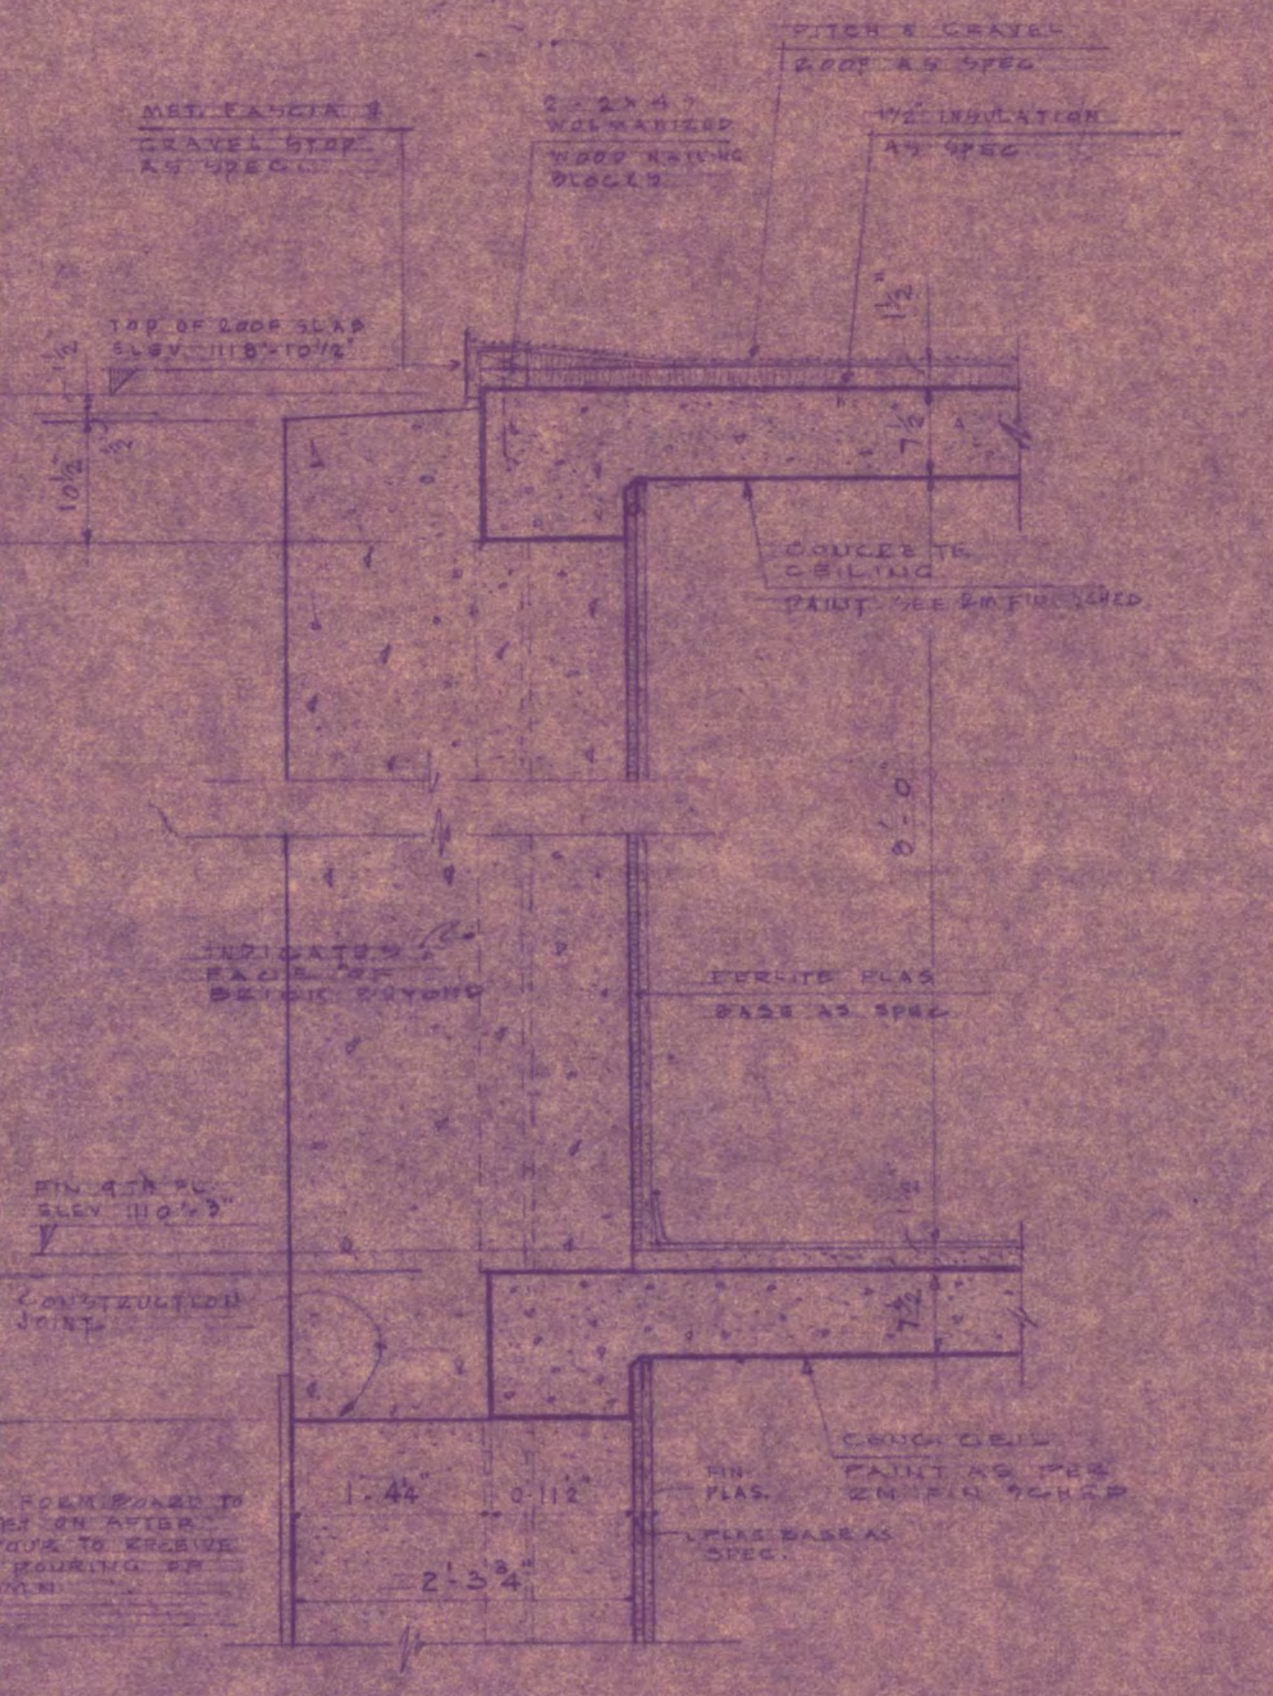

TYPICAL SECT THRU EXTERIOR CONC. COL @ FLOOR & ROOF  
SCALE 3/4"=1'-0"

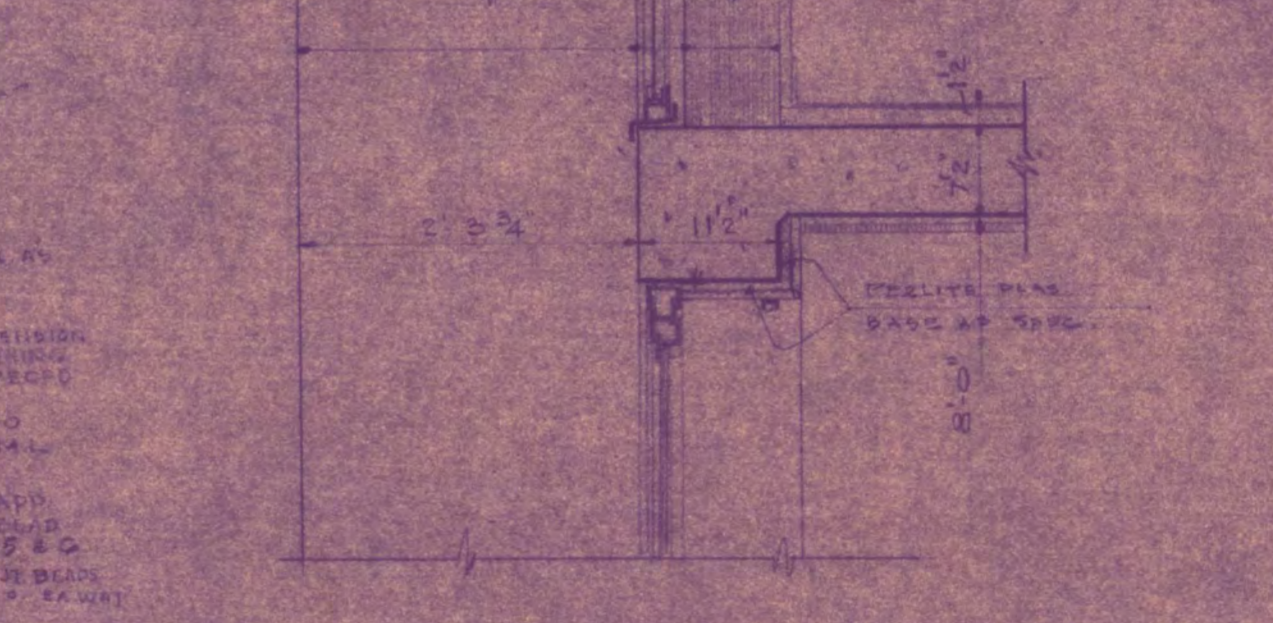


WALL SECTION BETWEEN COLUMNS NO. 7 & NO. 3  
SCALE 3/4"=1'-0"

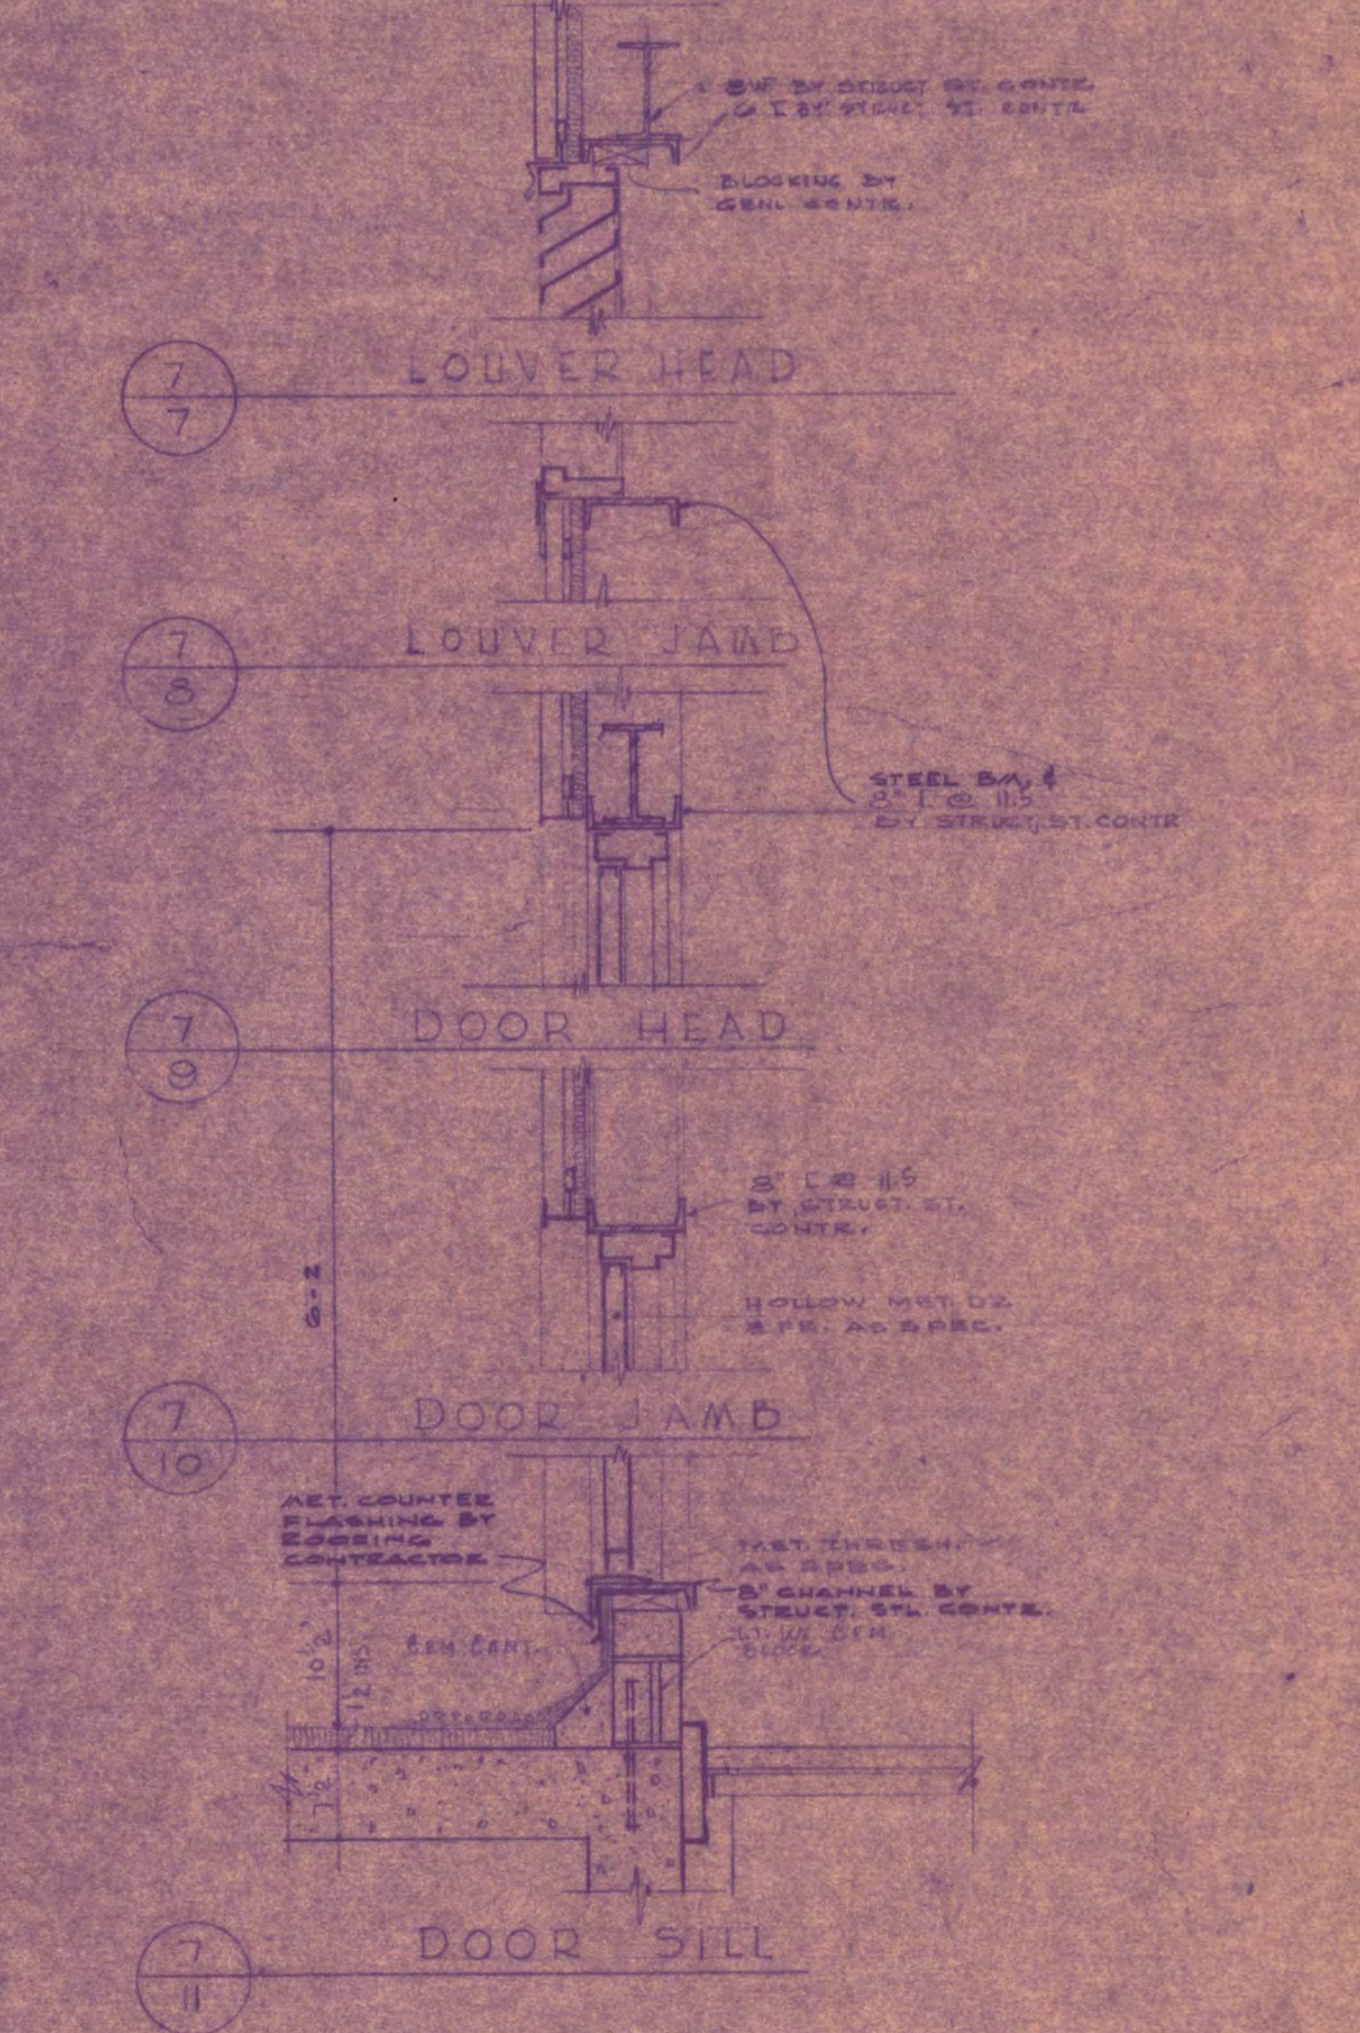


TYPICAL DETAILS THRU PENTHOUSE  
SCALE 3/4"=1'-0"

GIRLS DORMITORY ST. CLOUD STATE COLLEGE ST. CLOUD, MINNESOTA	
ARCHITECTS JACKSON-HAHN ASSOCIATES, INC. ST. CLOUD, MINNESOTA	DATE APPROVED BY DRAWN BY
7 10 E-1A	




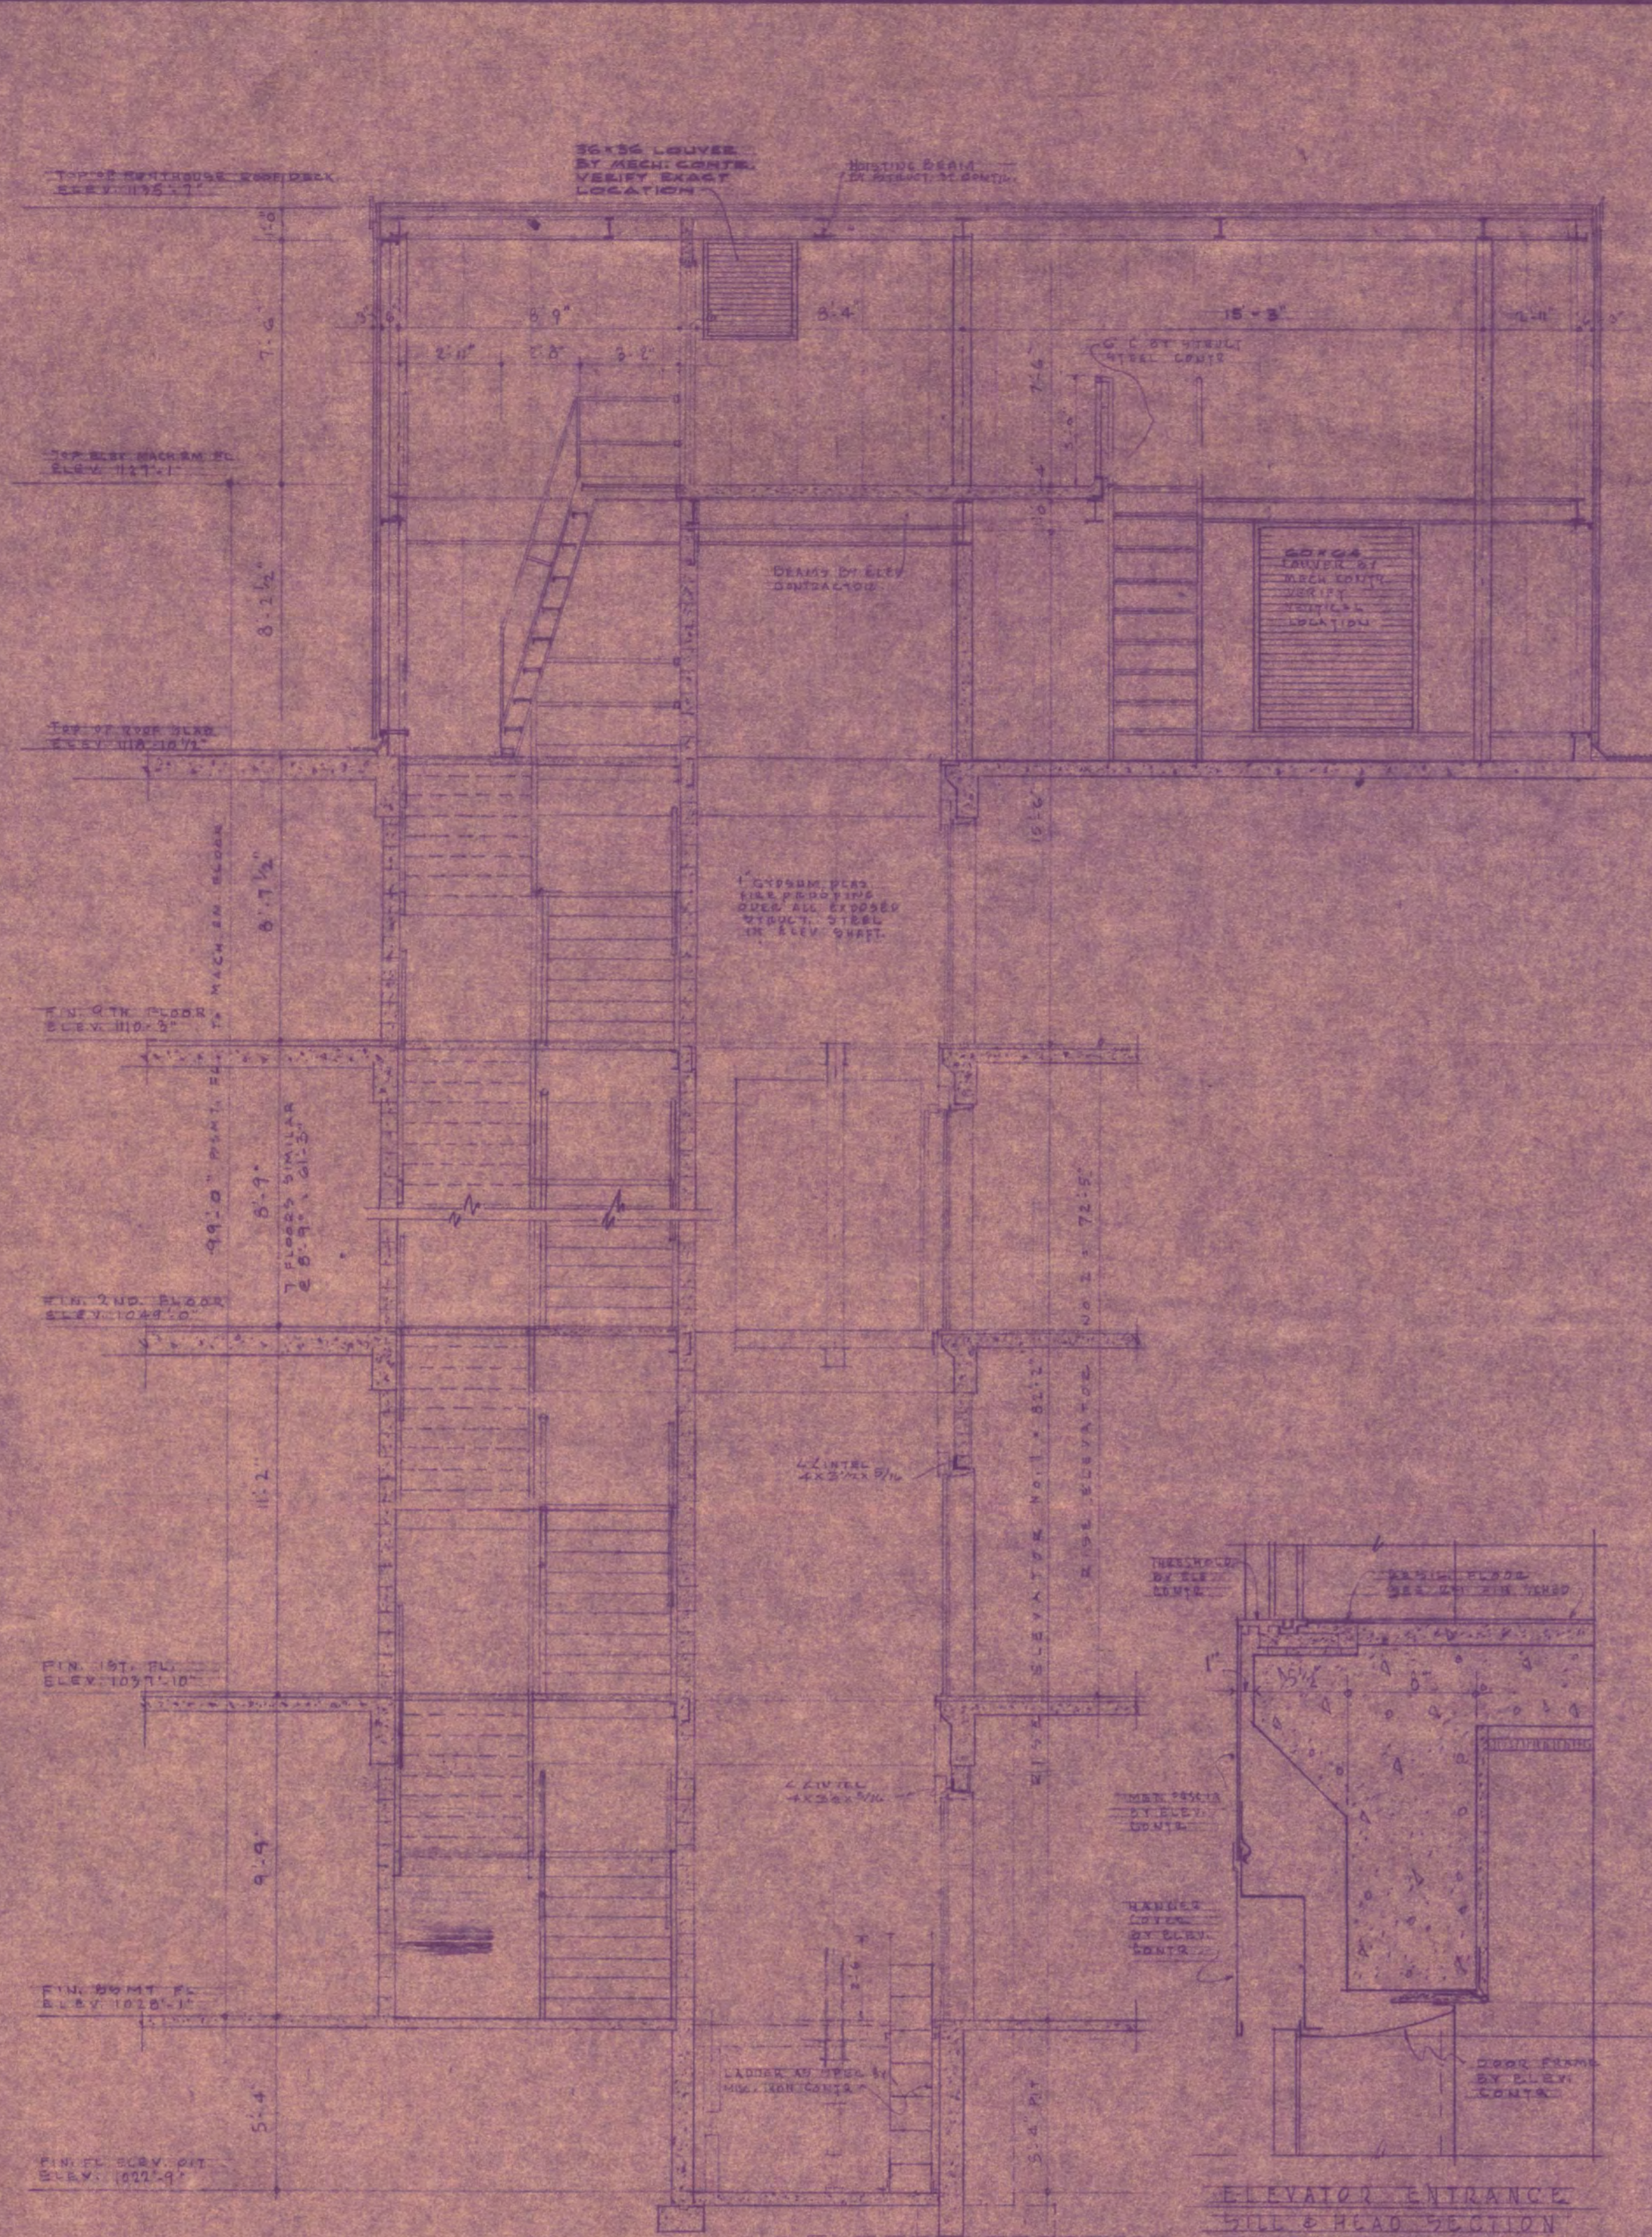


VERTICAL SECTION - STAIR A & ELEVATOR  
SCALE 1/4" = 1'-0"

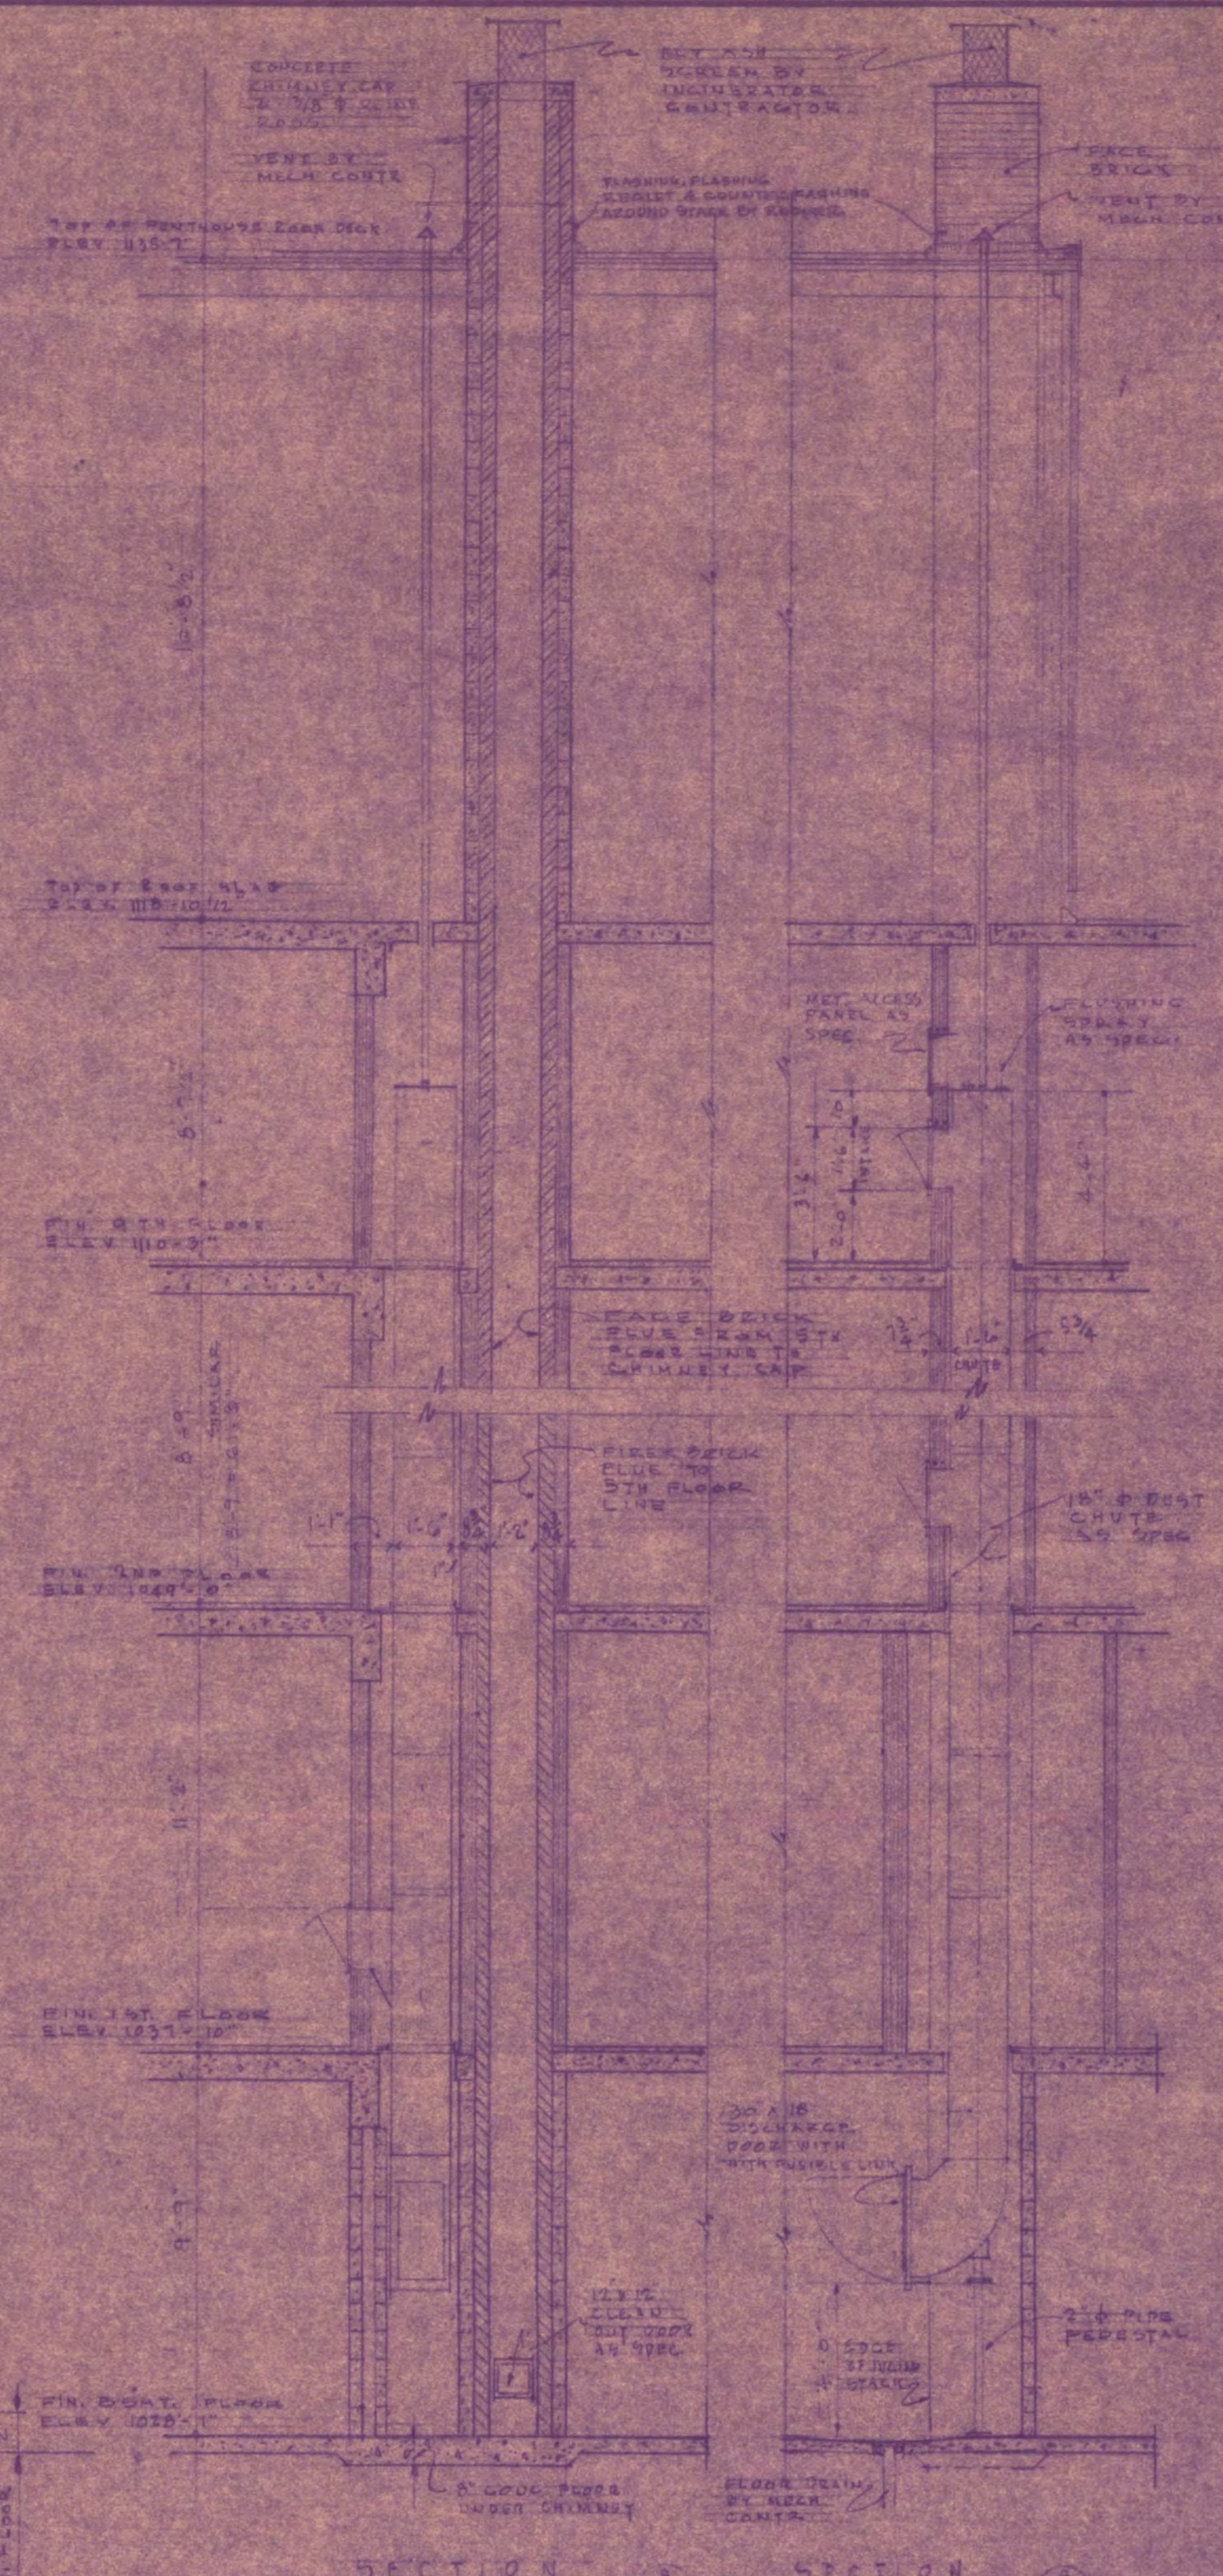

VERTICAL SECTION - STAIRS, CHUTE AND INCINERATOR STACK  
SCALE 1/4" = 1'-0"

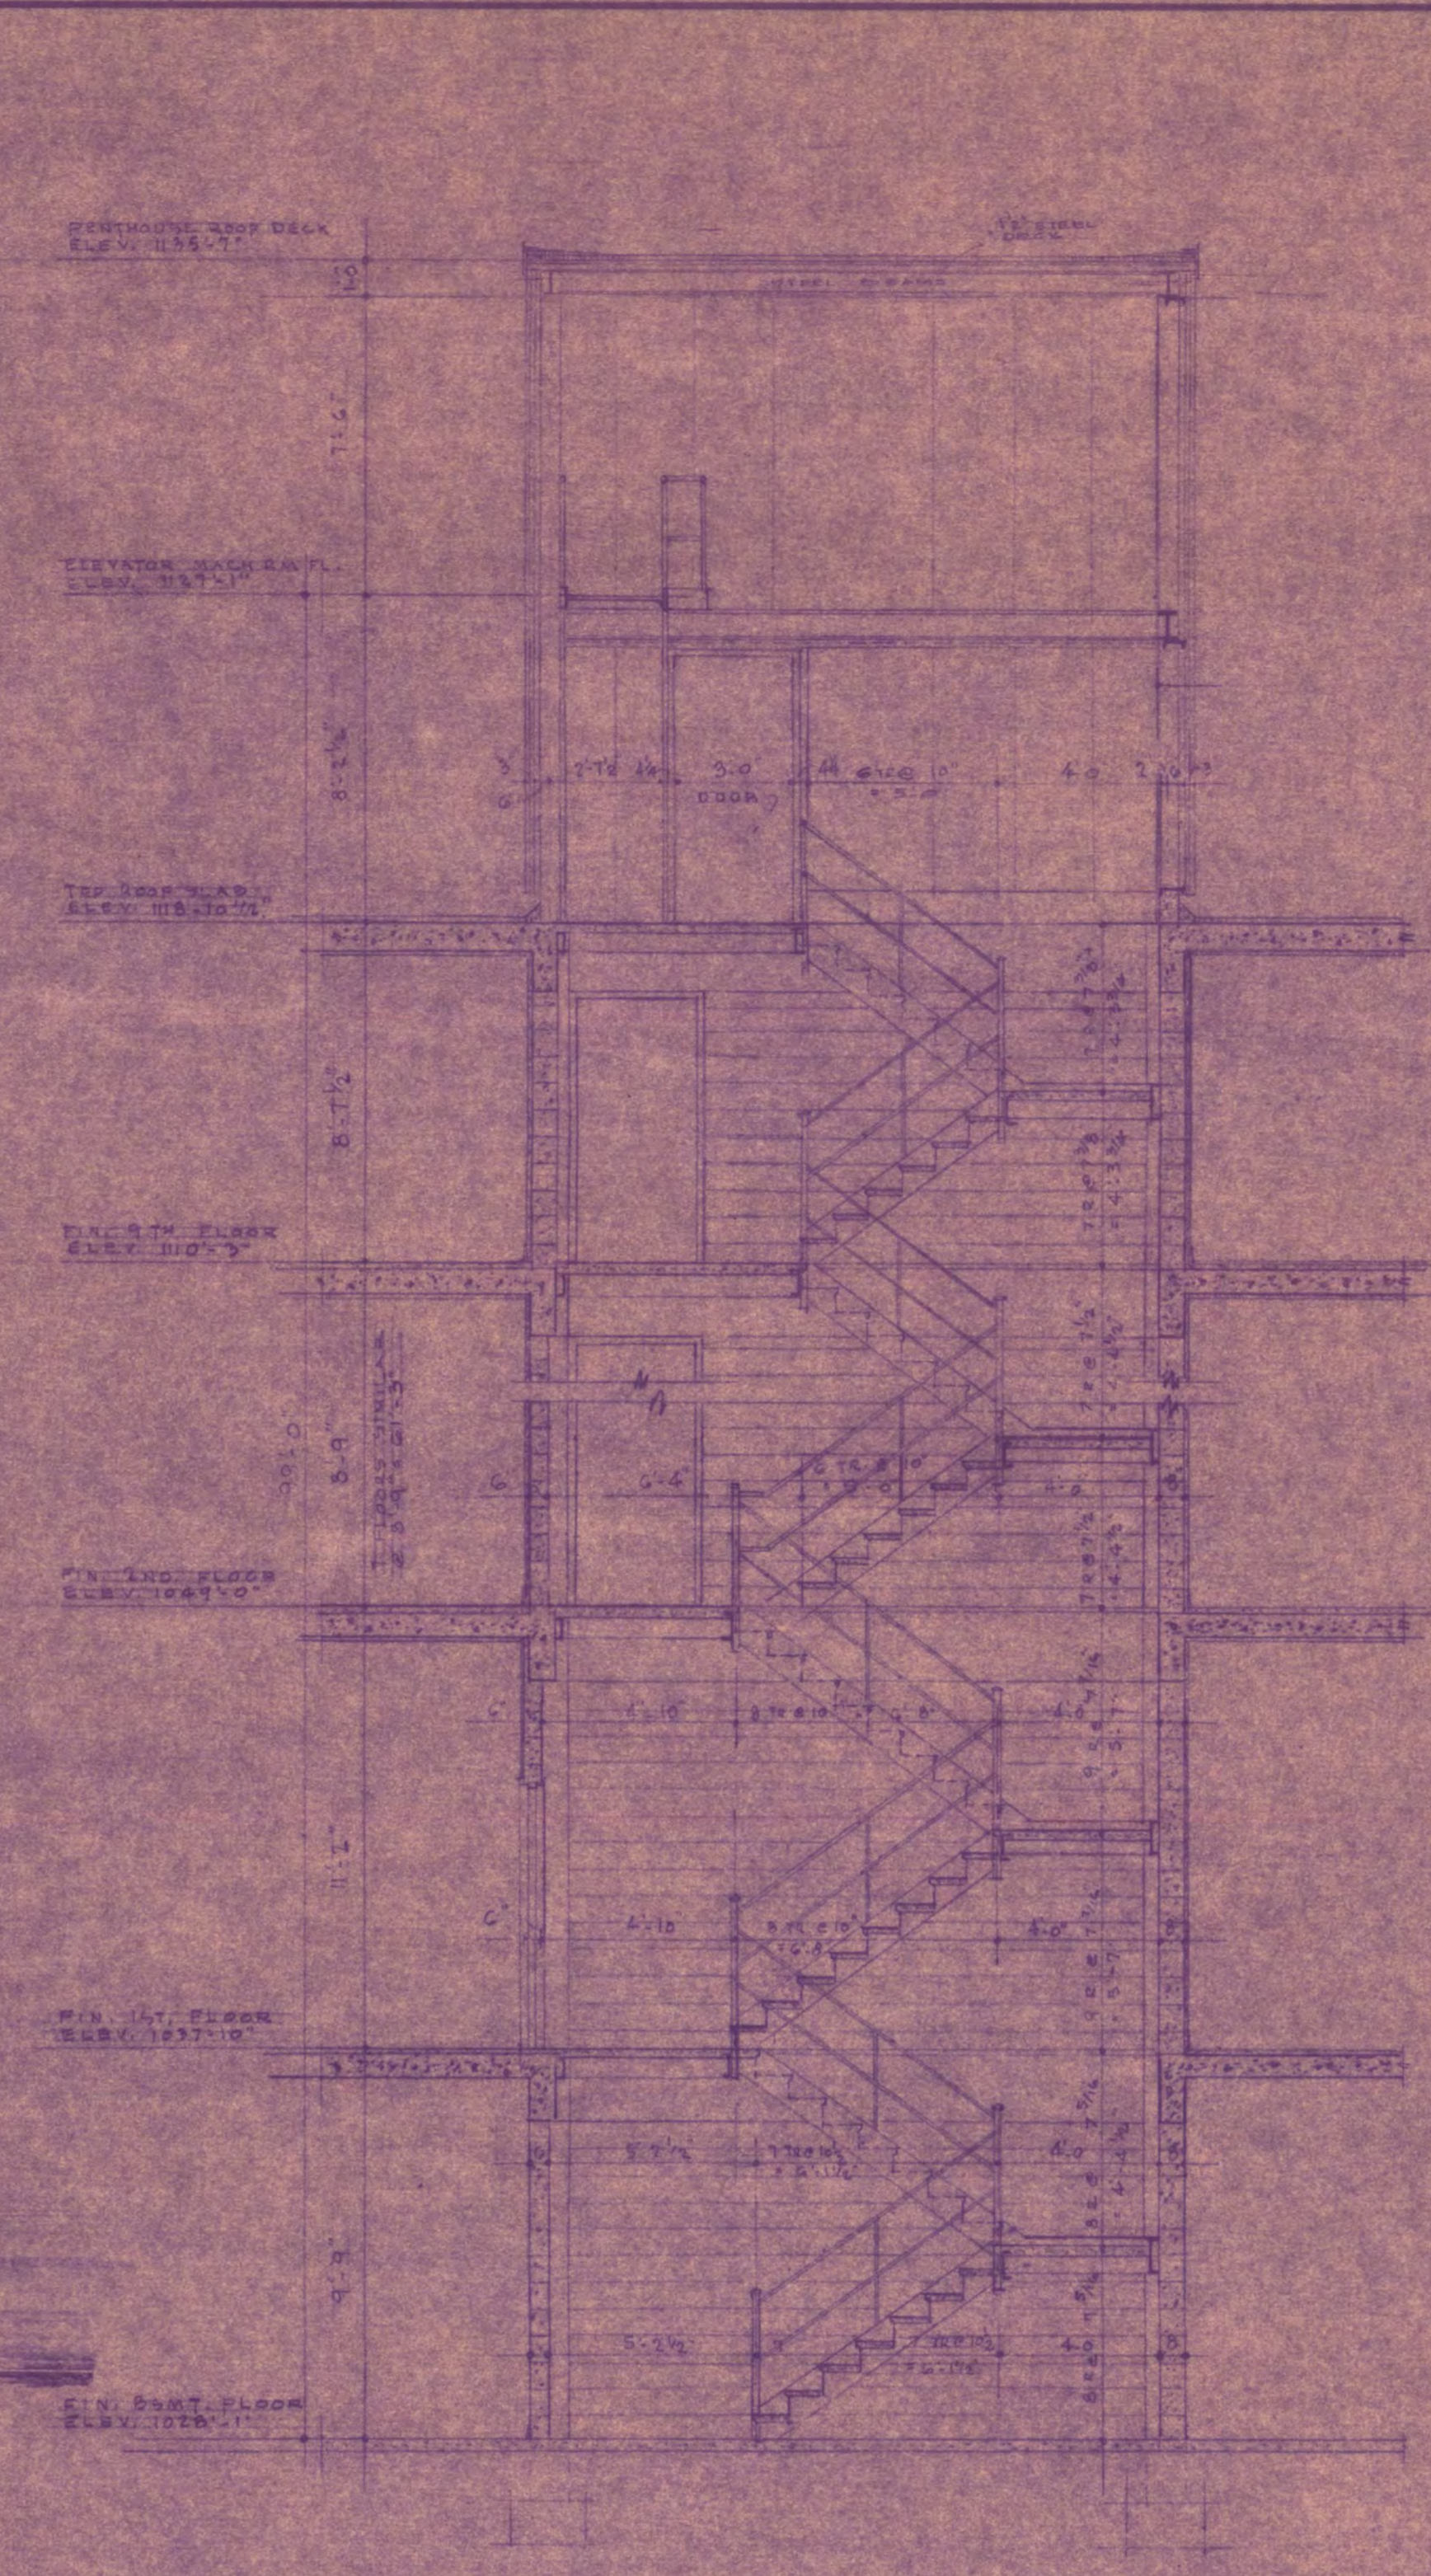


SECTION THRU STAIR 'K'  
SCALE 1/4" = 1'-0"

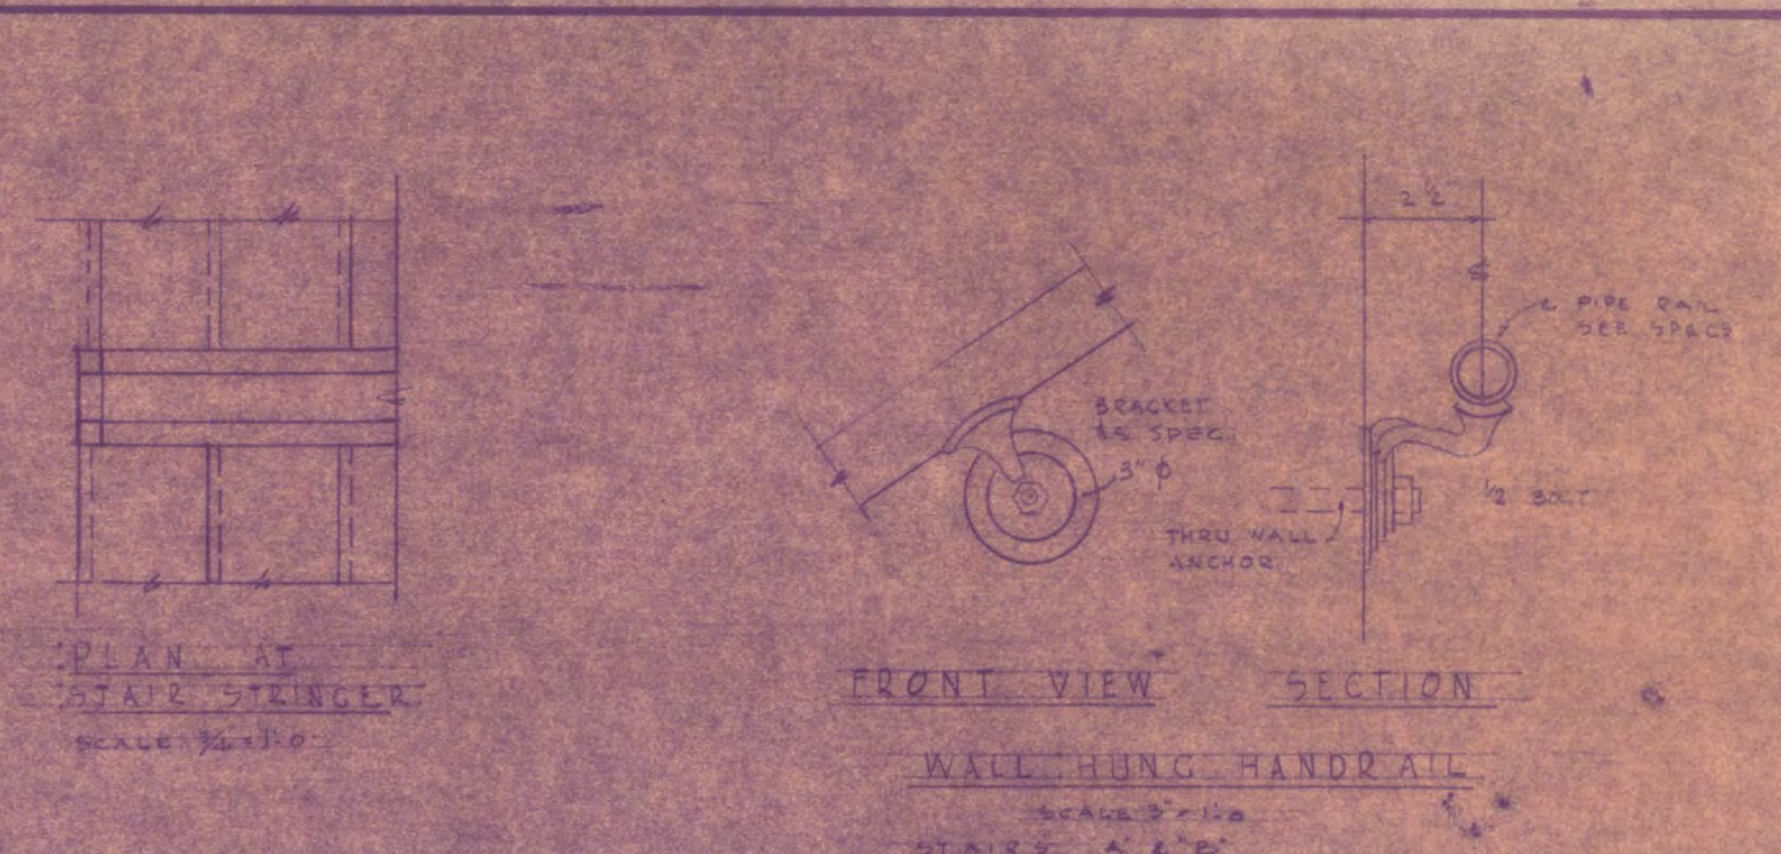


PLAN AT STAIR STRINGER  
SCALE 1/4" = 1'-0"


FRONT VIEW SECTION  
WALL HUNG HANDRAIL  
SCALE 1/4" = 1'-0"

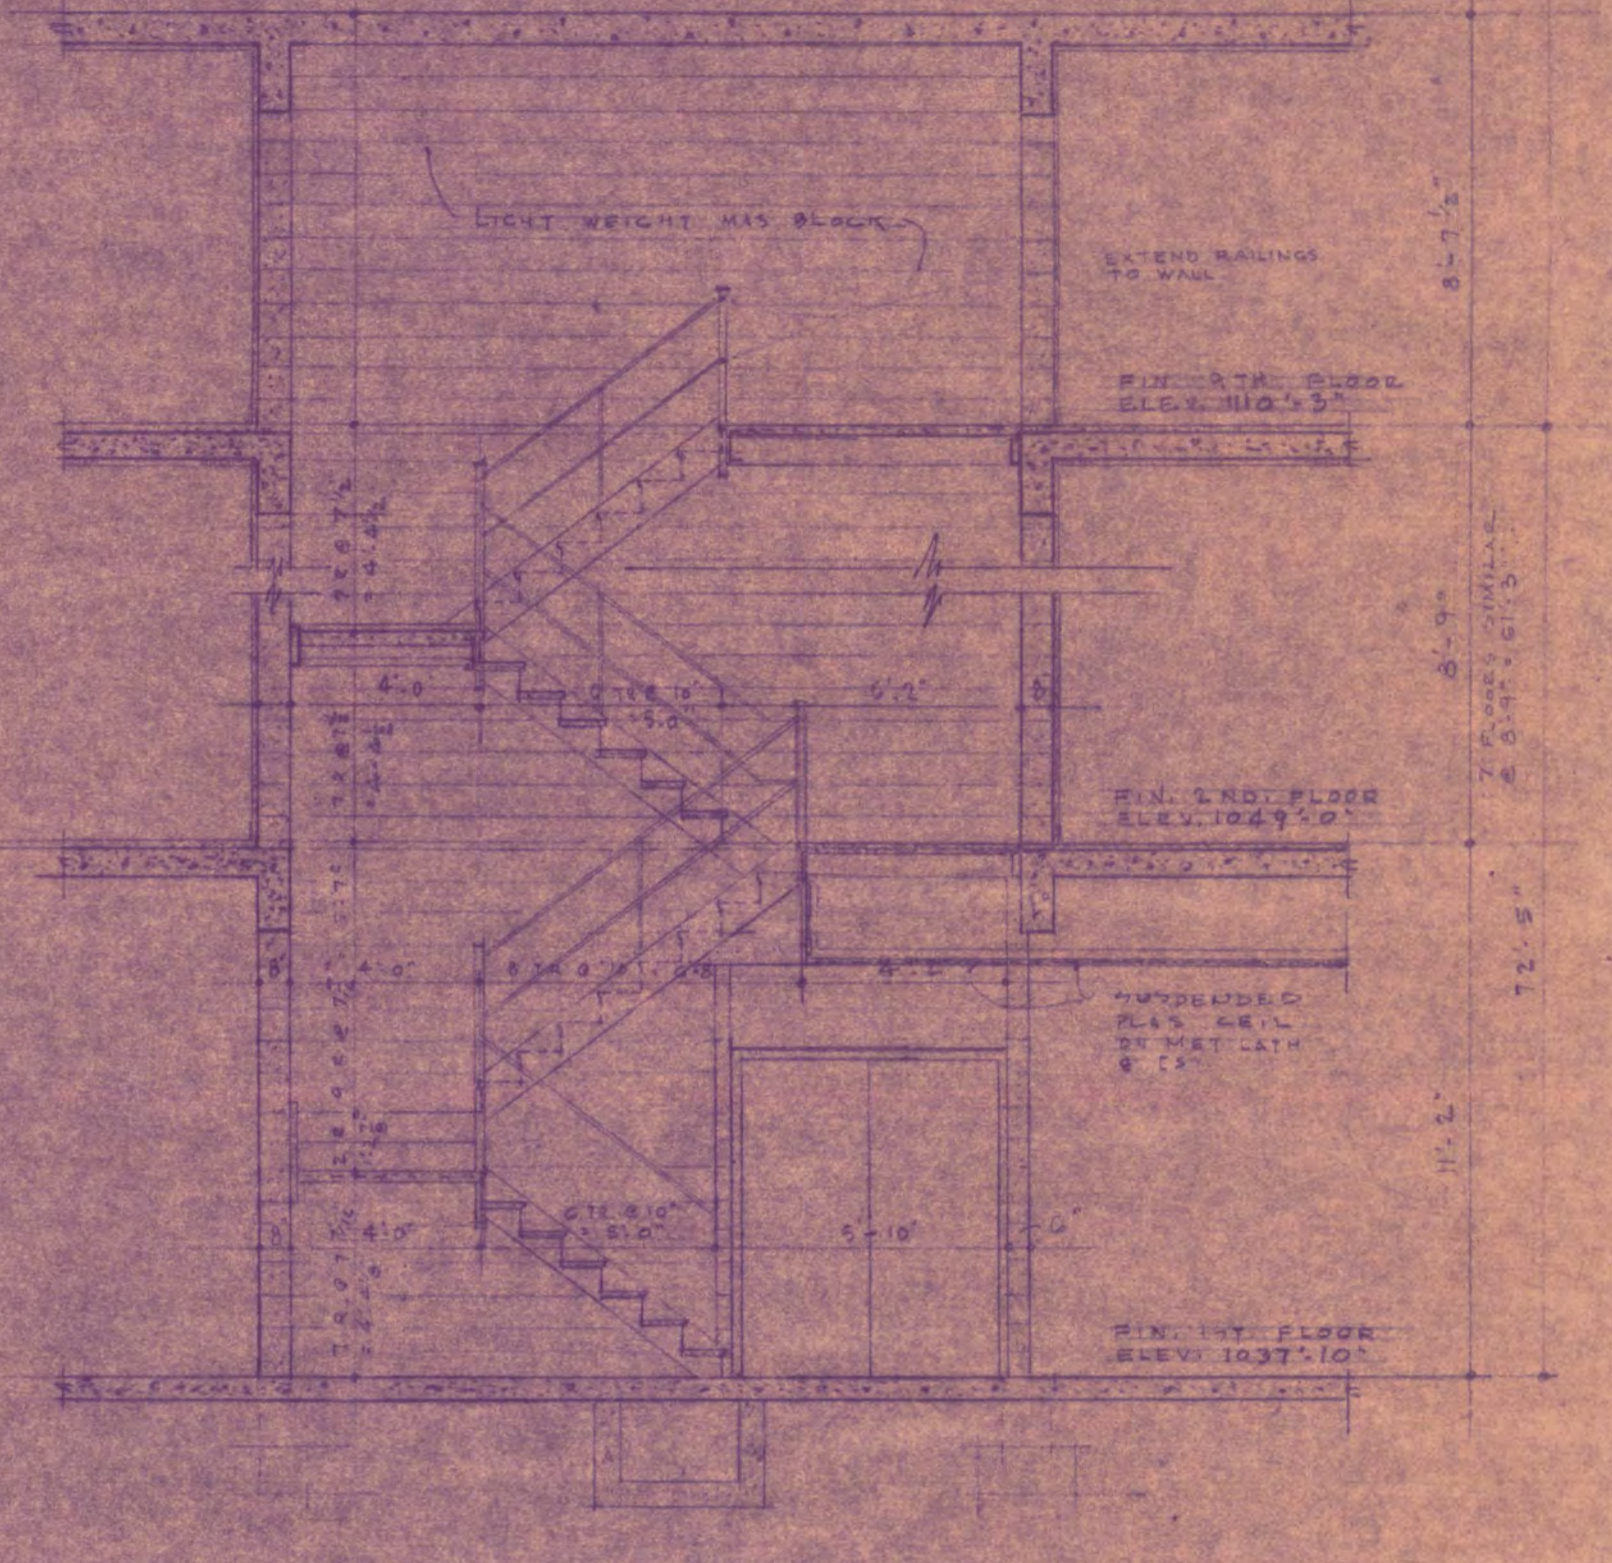


SECTION THRU STAIR 'E'  
SCALE 1/4" = 1'-0"

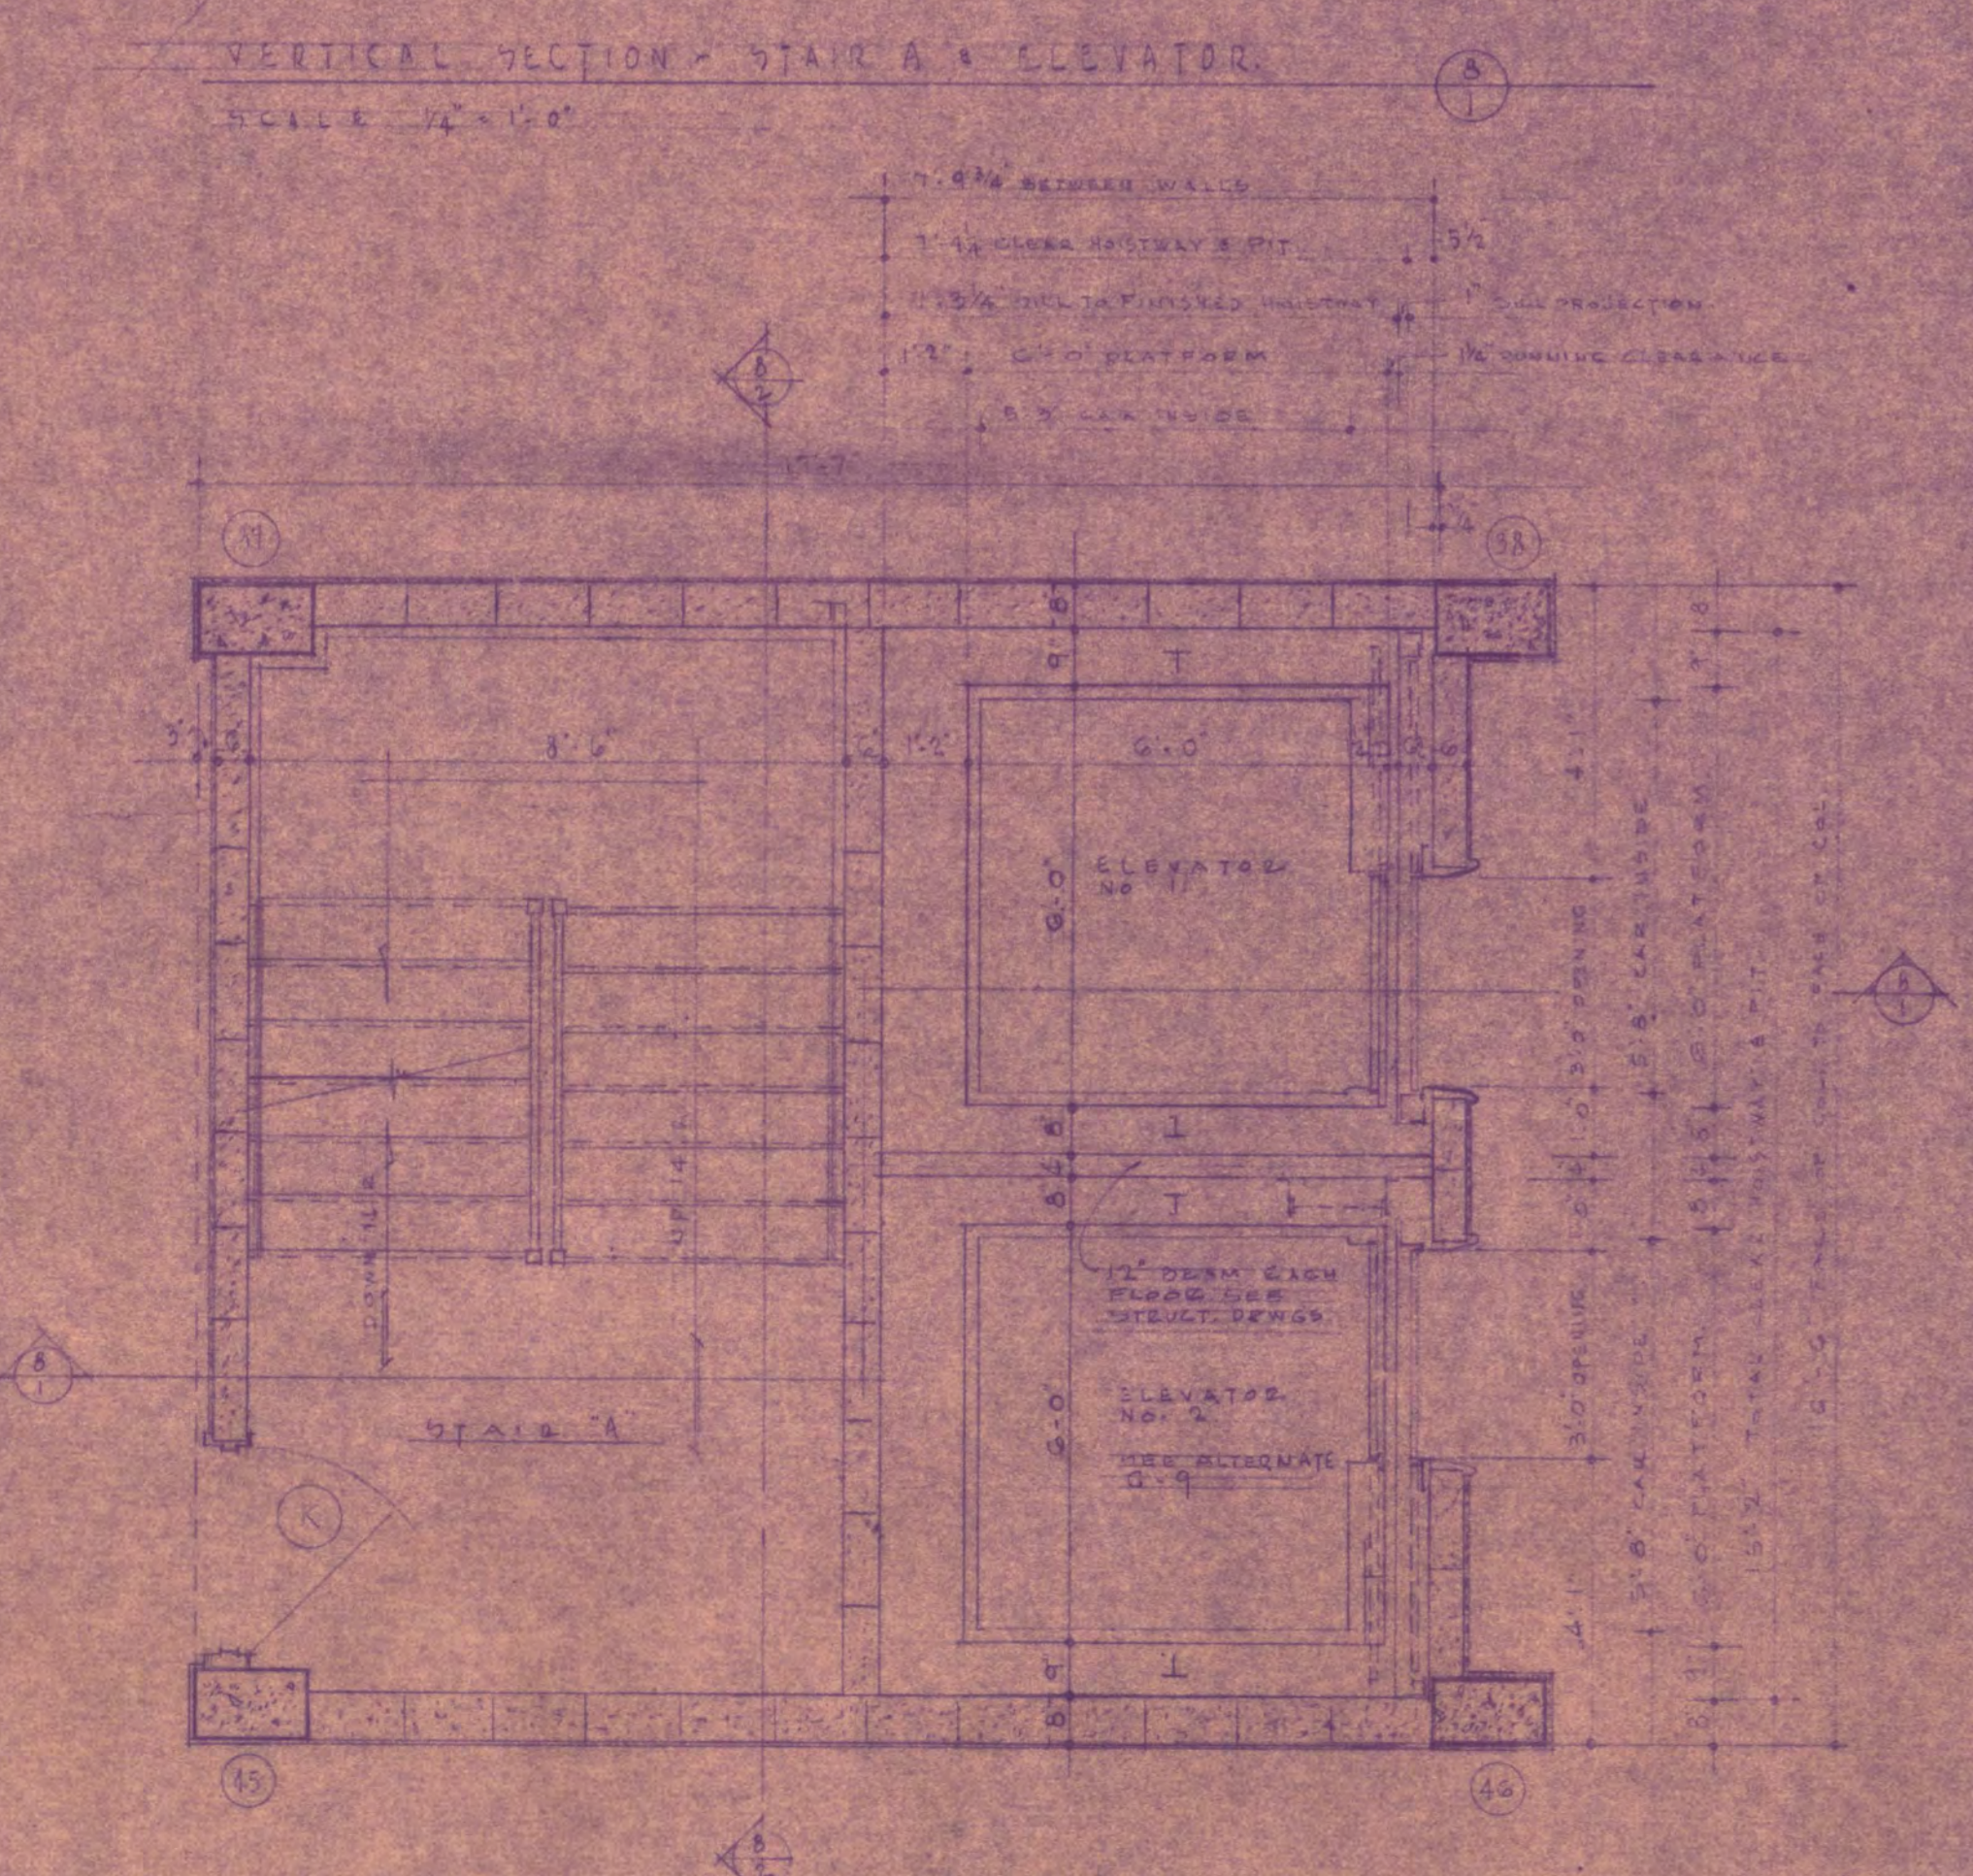


TYPICAL FLOOR PLAN - STAIR B & ELEVATOR  
SCALE 1/4" = 1'-0"

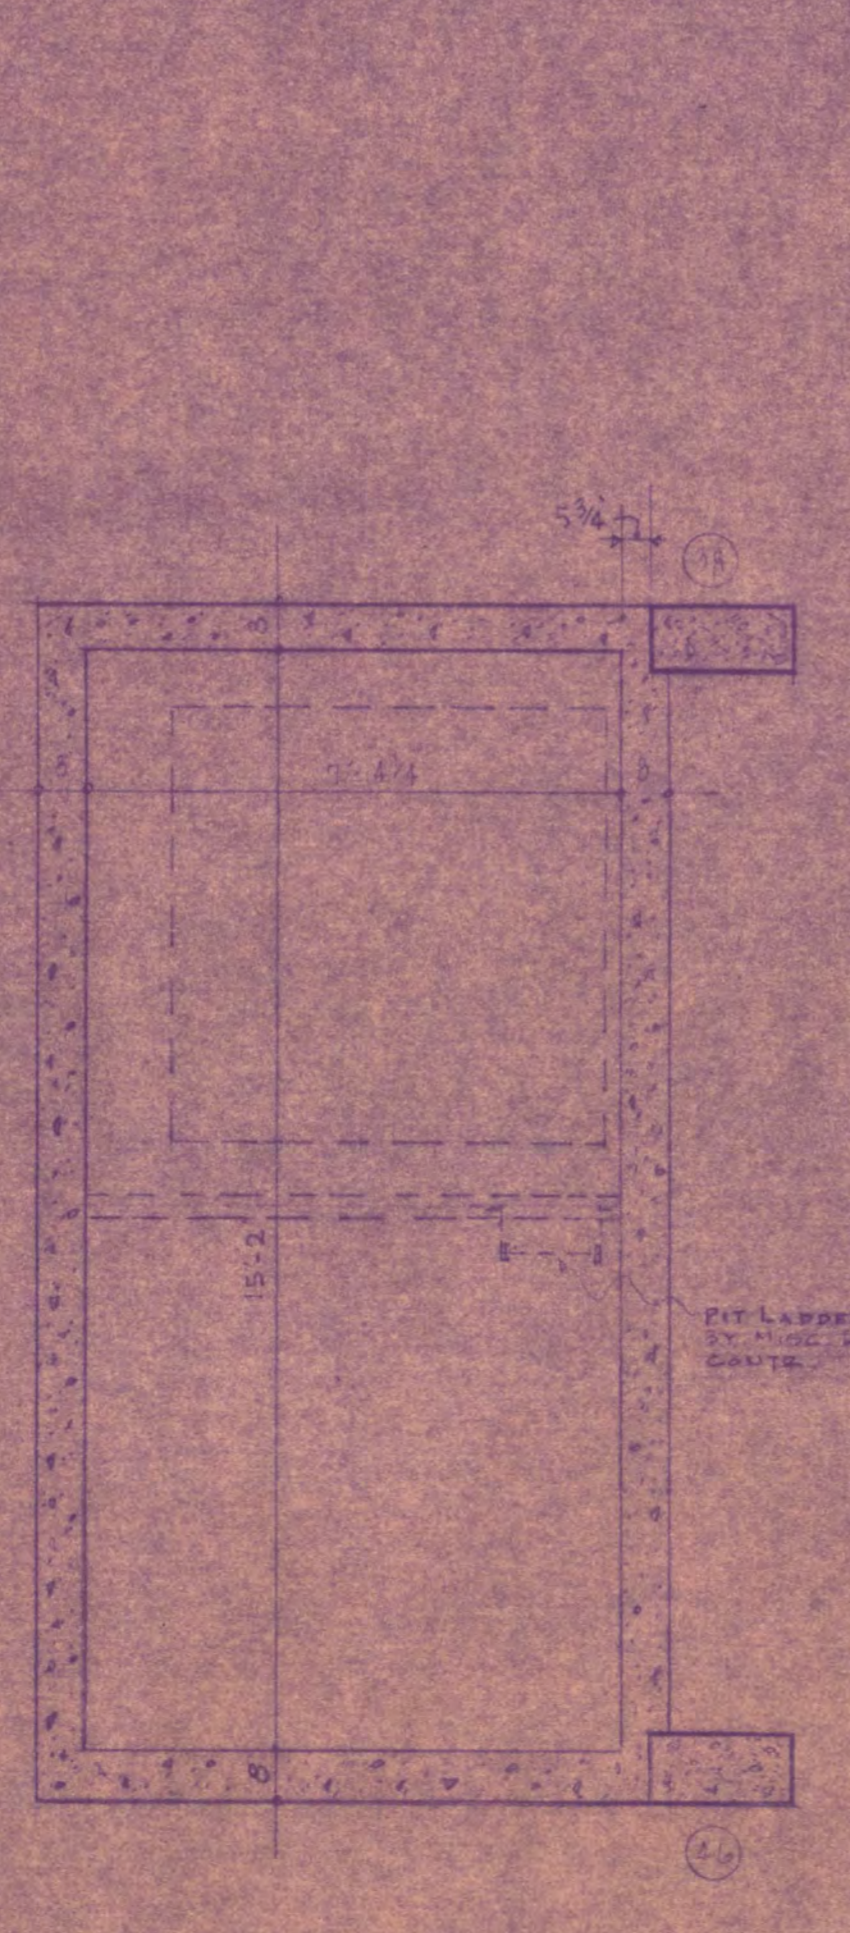


FLOOR PLAN - ELEVATOR SH  
SCALE 1/4" = 1'-0"

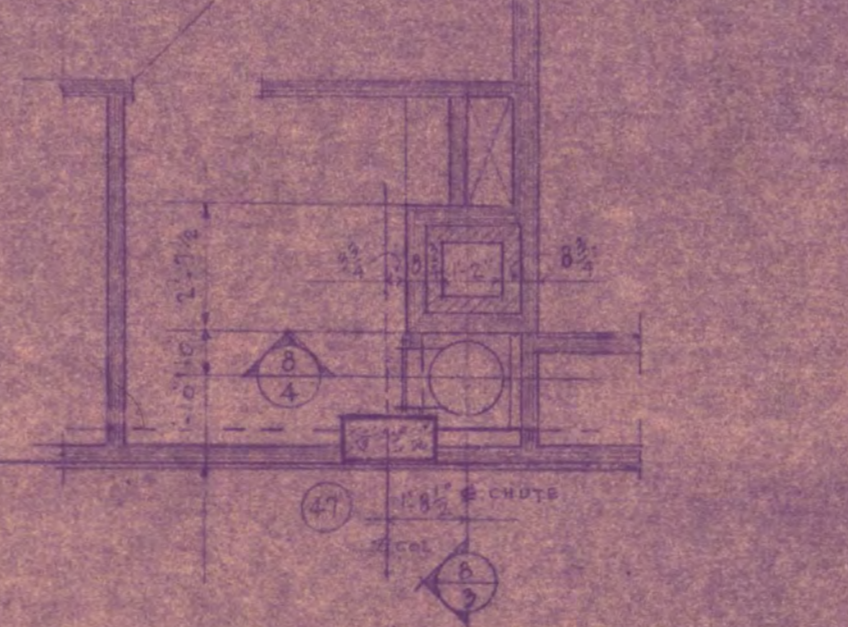


TYPICAL FLOOR PLAN AT RUBBISH CHUTE AND INCINERATOR STACK  
SCALE 1/4" = 1'-0"

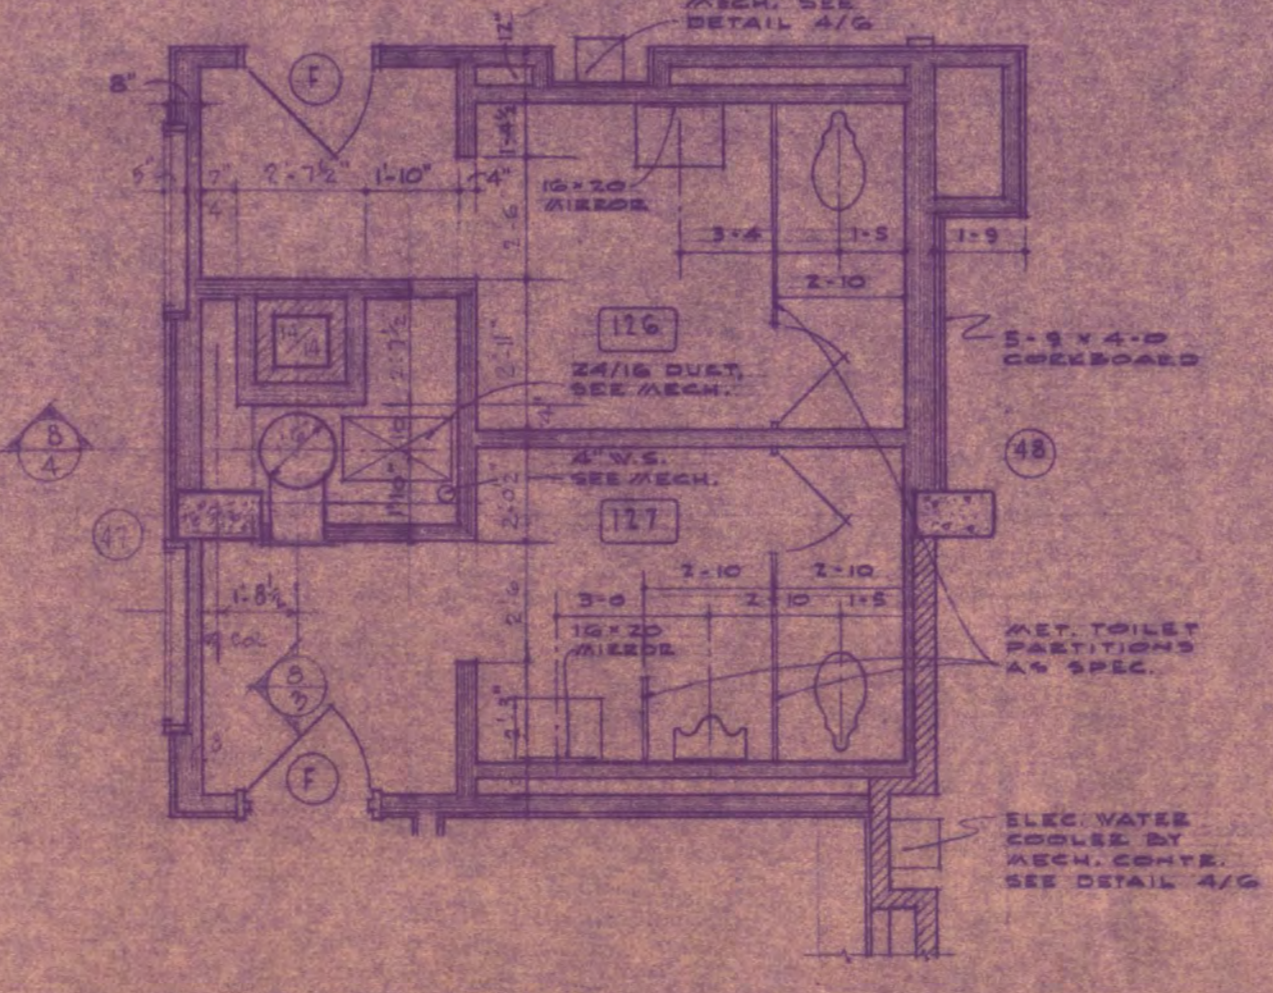


PART FIRST PLAN RUBBISH CHUTE, INCINERATOR STACK & TOILETS  
SCALE 1/4" = 1'-0"

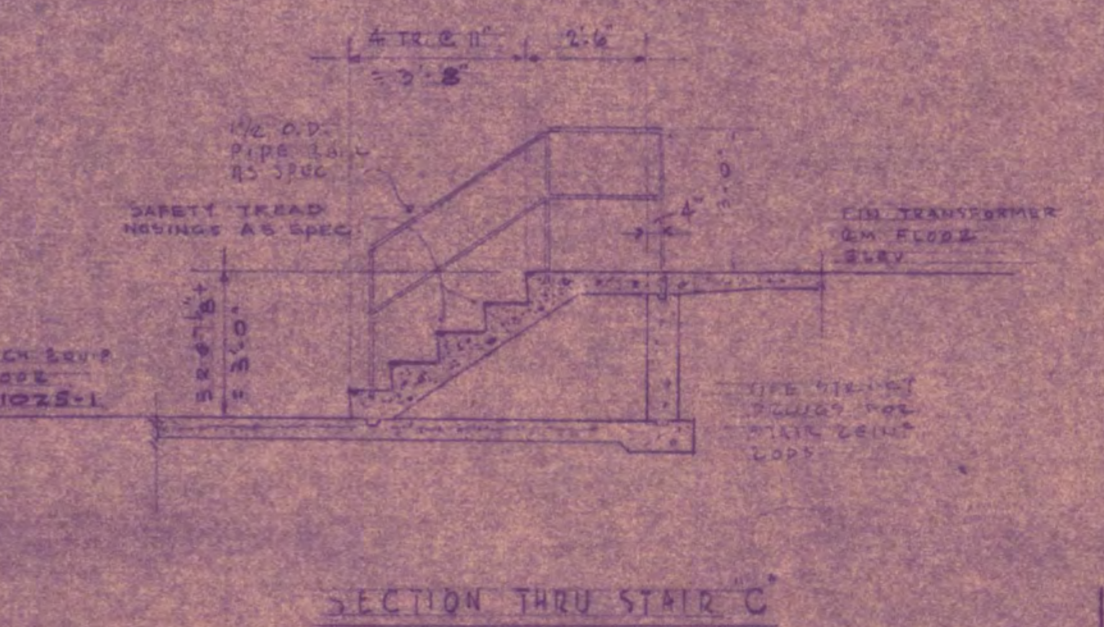

SECTION THRU STAIR 'C'  
SCALE 1/4" = 1'-0"

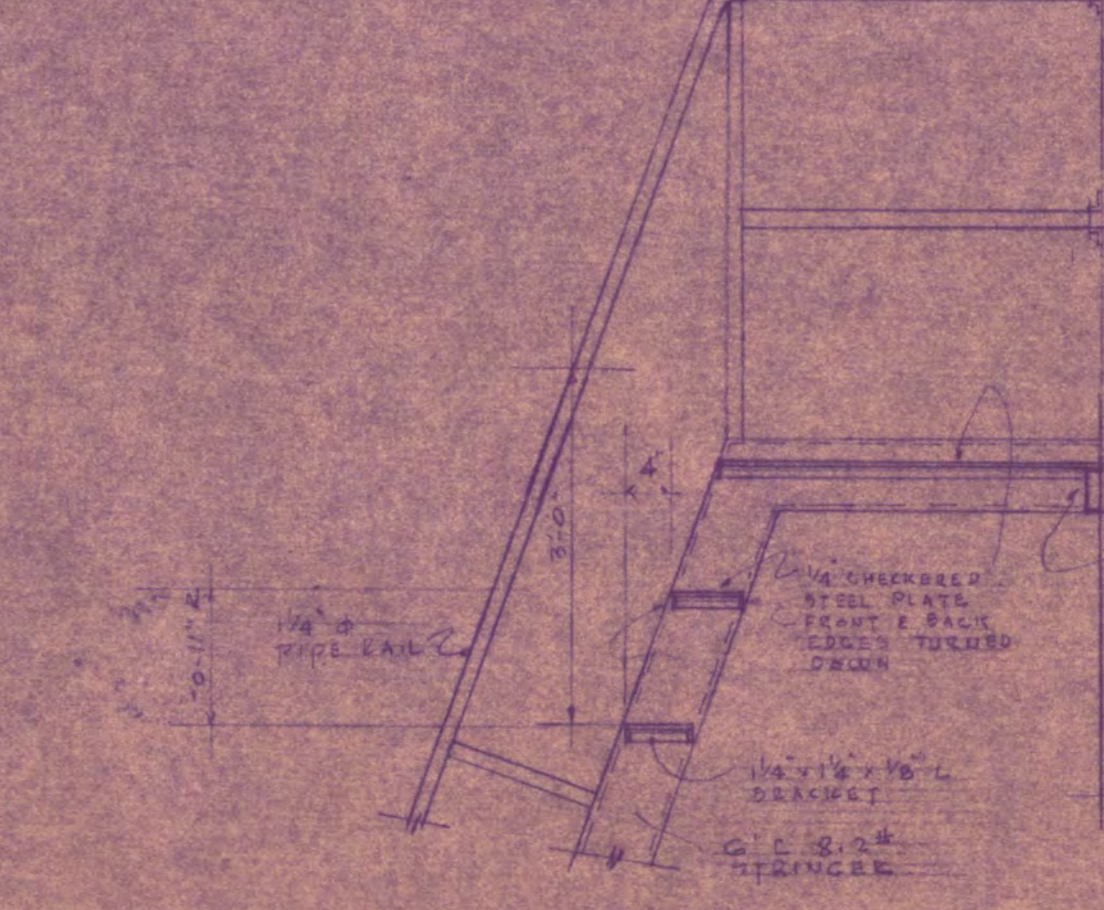

PART SECT THRU SHIP'S LADDER TO MACHINE RM. FLOOR  
SCALE 1/4" = 1'-0"

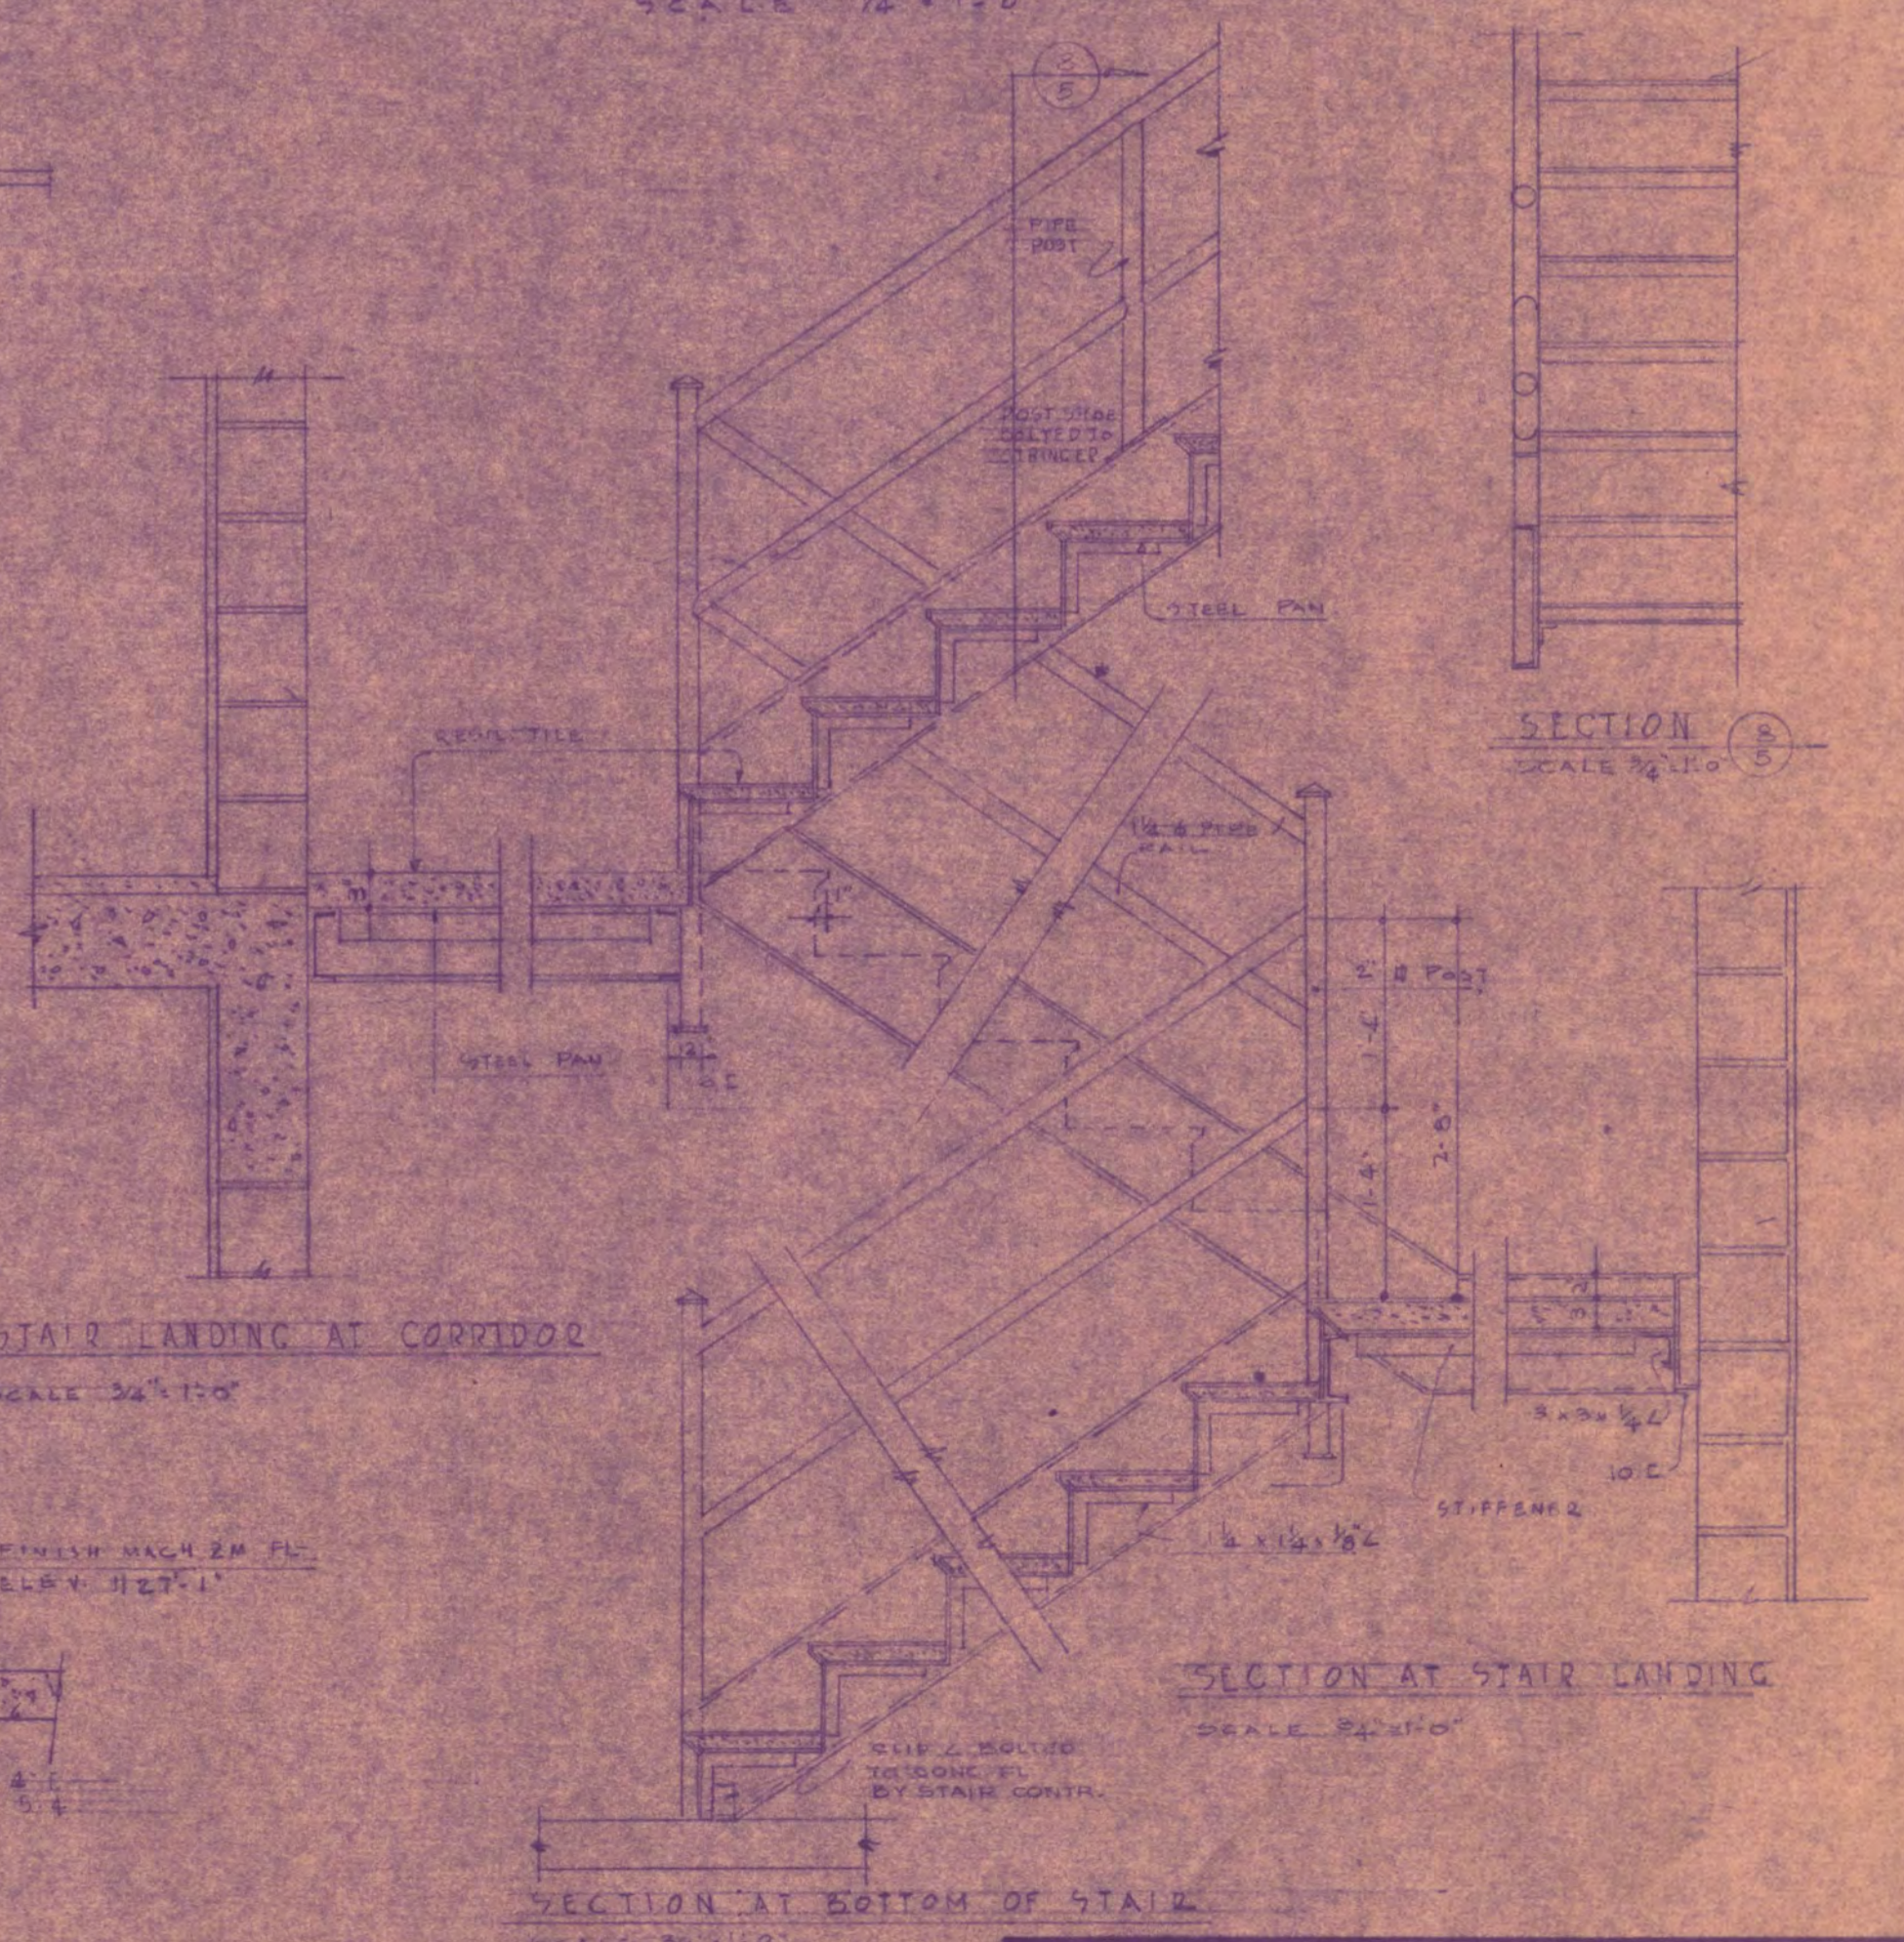


SECTION AT STAIR LANDING  
SCALE 1/4" = 1'-0"

SECTION AT BOTTOM OF STAIR  
SCALE 1/4" = 1'-0"

GIRLS' DORMITORY ST. CLOUD STATE COLLEGE ST. CLOUD, MINNESOTA		
OWNER	JACKSON HAHN ASSOCIATES, INC.	PROJECT NO.
DESIGNER	ST. CLOUD	DATE
DATE	APPROVED BY	SCALE
REVISIONS	APPROVED BY	DATE
	APPROVED BY	
	APPROVED BY	



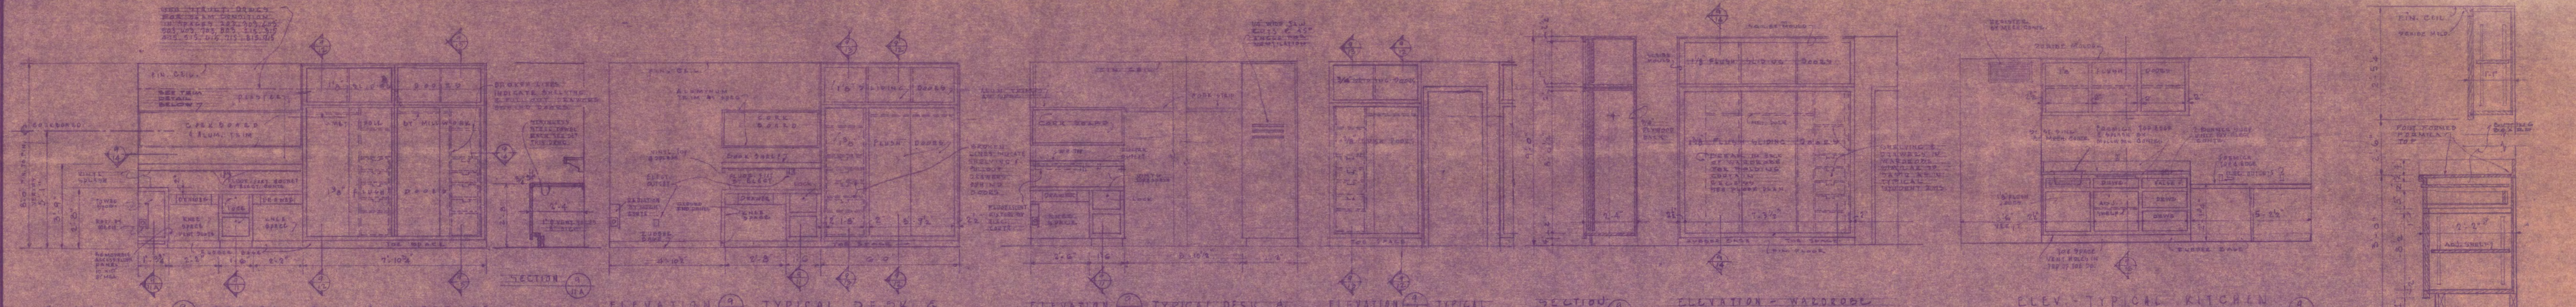

ELEVATION 1 TYPICAL DESK & WARDROBE FOR STUDENT BED ROOMS  
SCALE 3/8" = 1'-0"  
DASH EXTERIOR - PINE INTERIOR

ELEVATION 2 TYPICAL DESK & WARDROBE SUPERVISORS R.M.  
SCALE 3/8" = 1'-0"  
DASH EXTERIOR - PINE INTERIOR


ELEVATION 3 TYPICAL DESK & WARDROBE STUDENT BED ROOMS  
ALTERNATE NUMBER G-1  
SCALE 3/8" = 1'-0"

ELEVATION 4 TYPICAL WARDROBE STUDENT BED ROOMS  
ALTERNATE NO. G-1  
SCALE 3/8" = 1'-0"

ELEVATION - WARDROBE SUPERVISORS BED ROOM-SPACE 109  
SCALE 3/8" = 1'-0"  
DASH EXTERIOR - PINE INTERIOR

ELEV. - TYPICAL KITCHEN COUNTER, ACTIVITY AND SCALE 3/8" = 1'-0"  
DASH EXTERIOR - PINE INTERIOR


SECT. KITCHEN CAB. ACTIVITY RM.  
SCALE 3/8" = 1'-0"

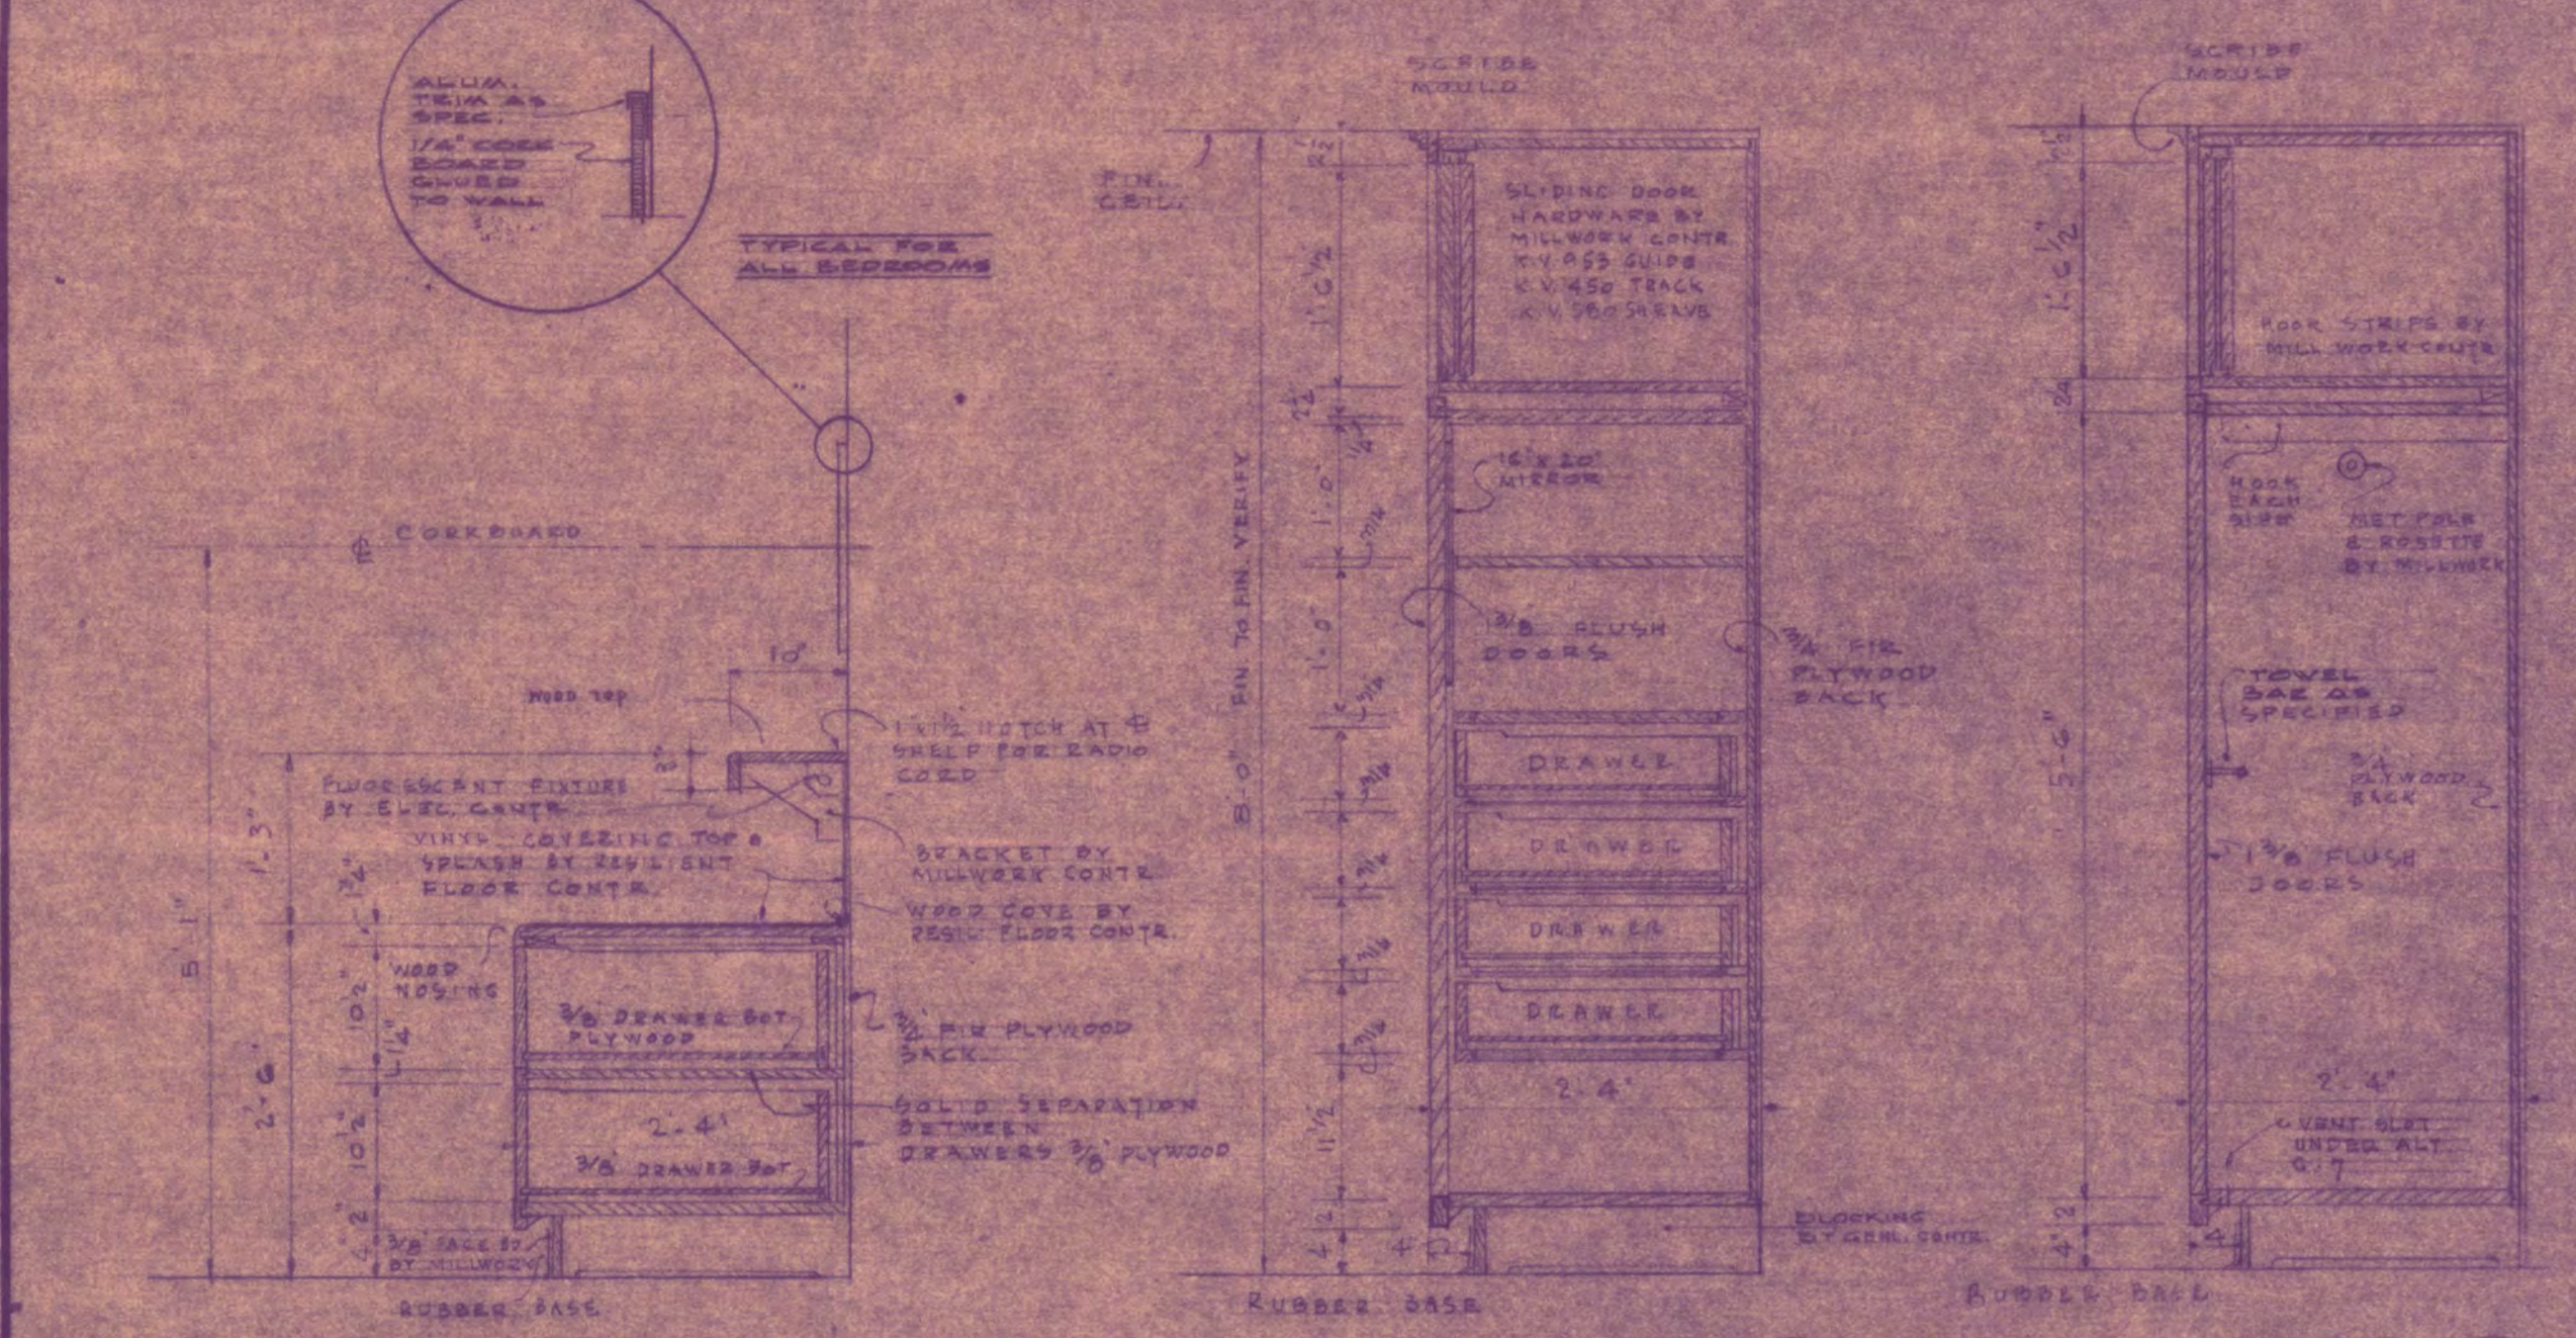


SECT. - DESK BED ROOMS  
SCALE 3/8" = 1'-0"

SECT. DRAWING & DESK BED RM. WARDROBE  
SCALE 3/8" = 1'-0"


SECT. ON THRU BED RM. WARDROBE  
SCALE 3/8" = 1'-0"

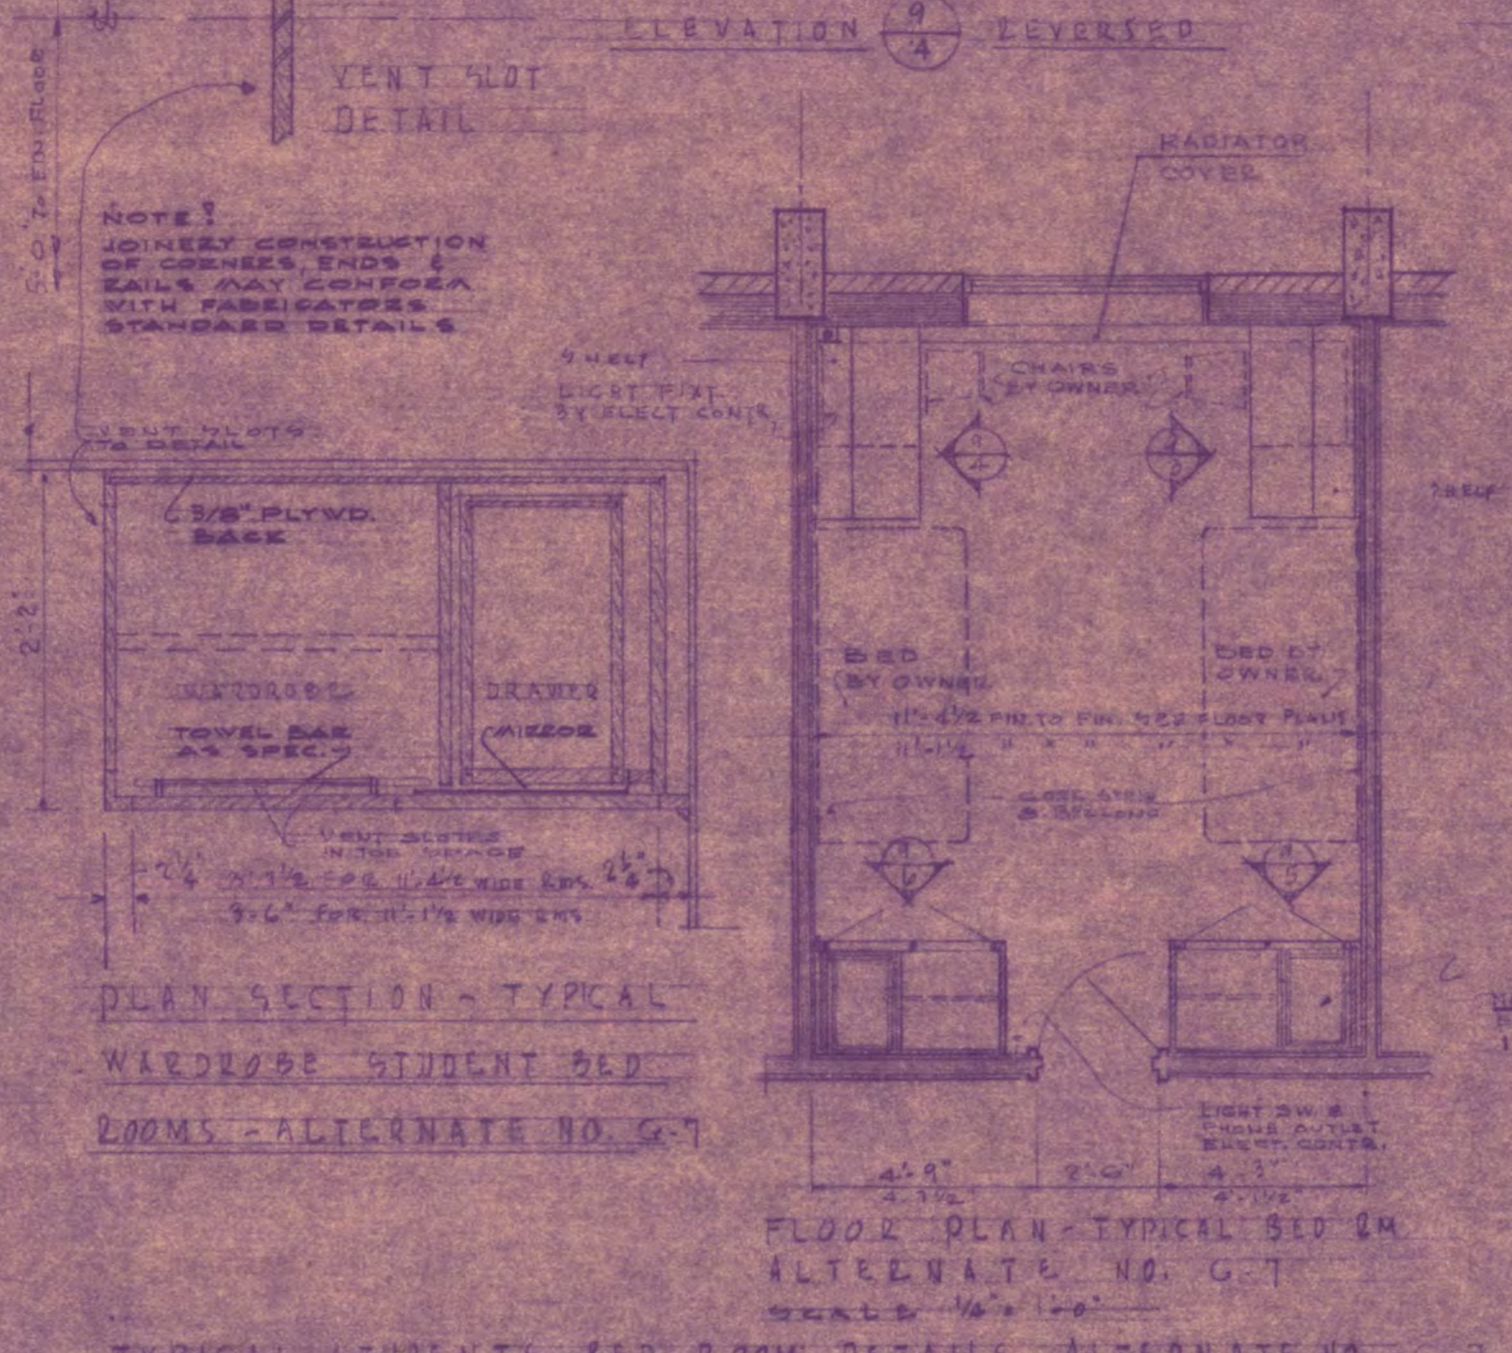


PLAN SECTION - TYPICAL WARDROBE STUDENT BED ROOMS - ALTERNATE NO. G-1  
SCALE 3/8" = 1'-0"

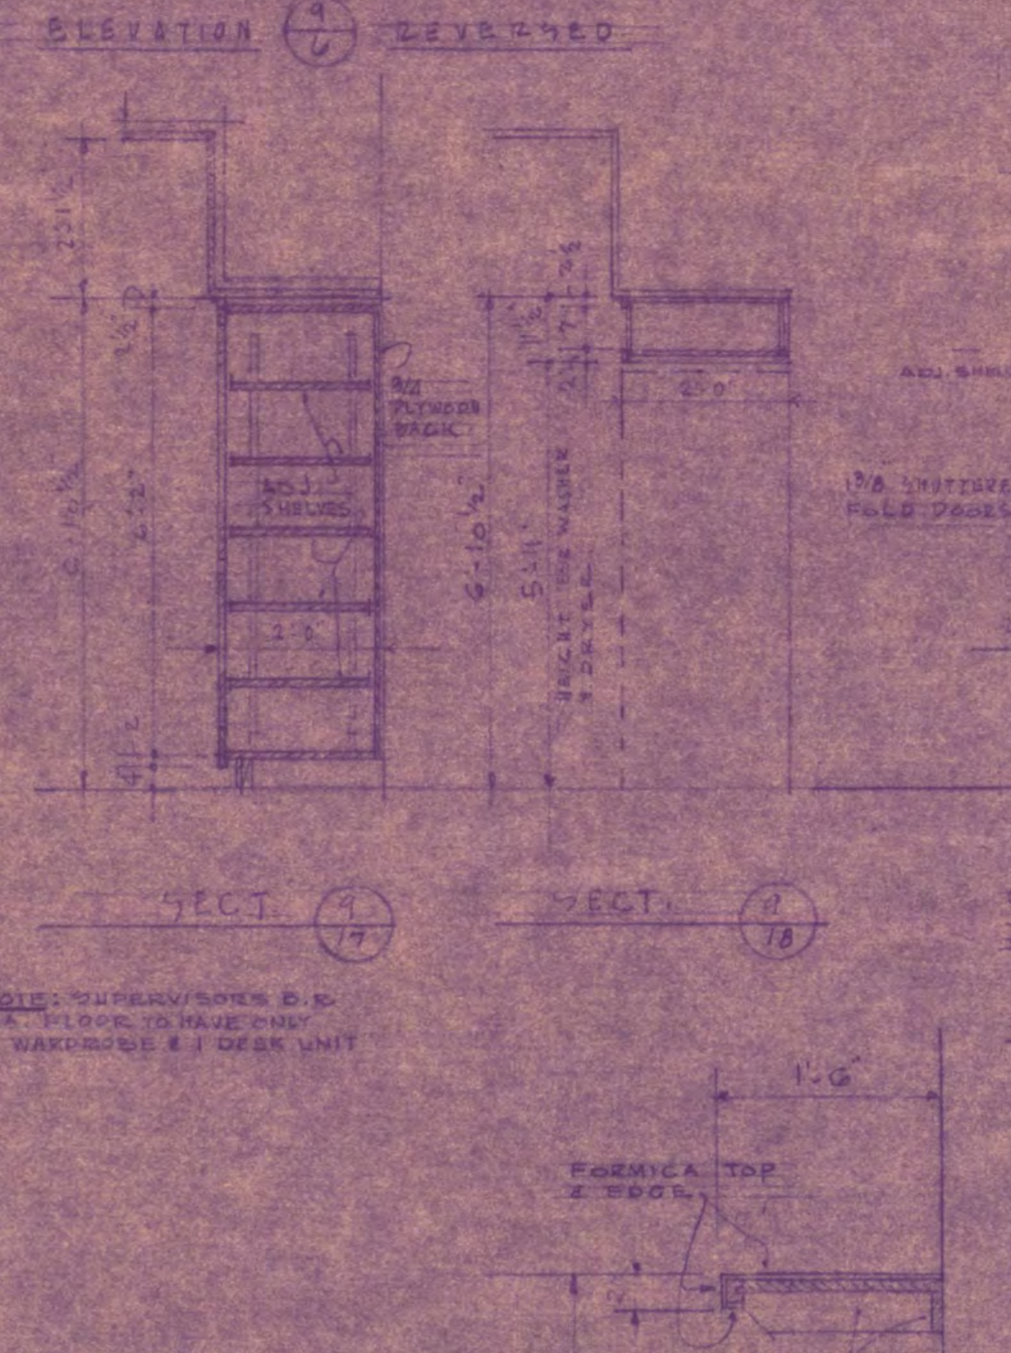


FLOOR PLAN TYPICAL BED RM. ALTERNATE NO. G-1  
SCALE 3/8" = 1'-0"

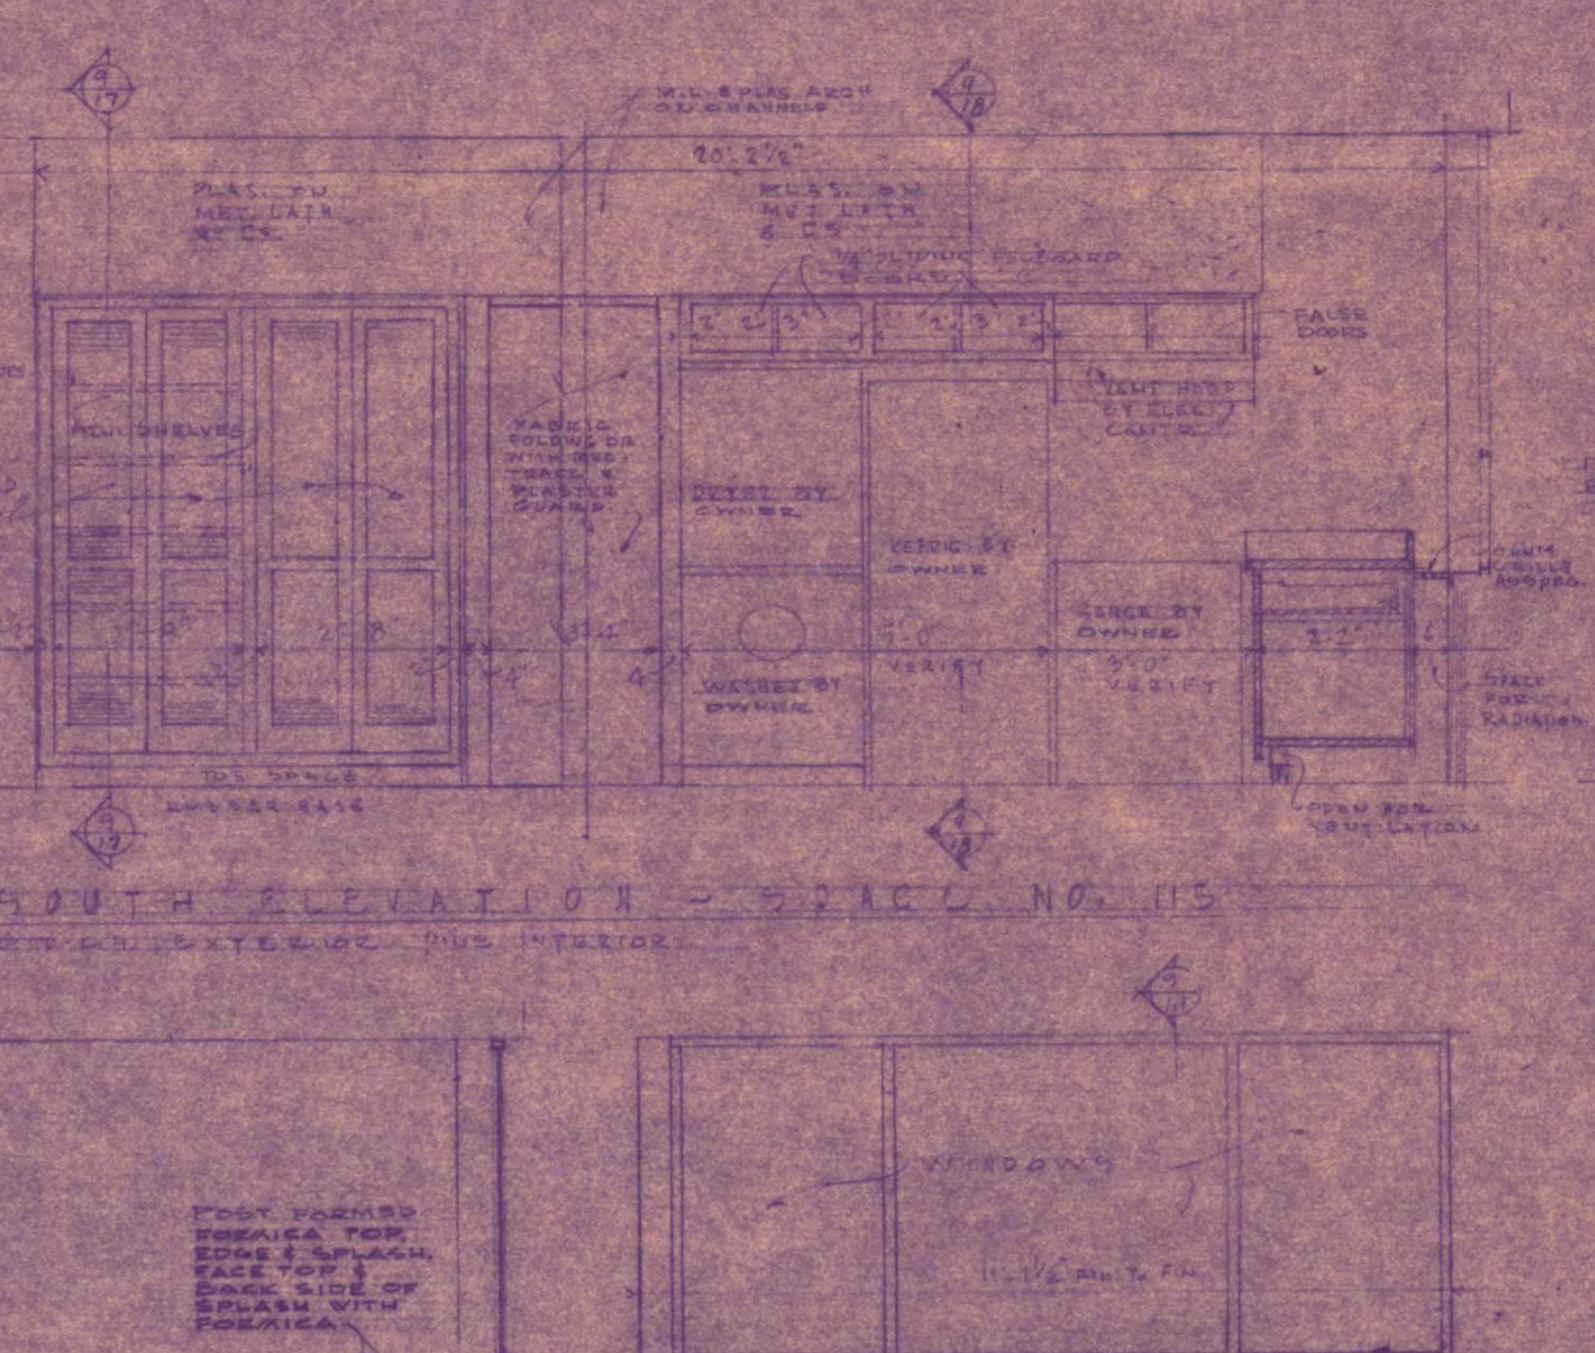


YOUTH ELEVATION - SPACE NO. 115  
SCALE 3/8" = 1'-0"

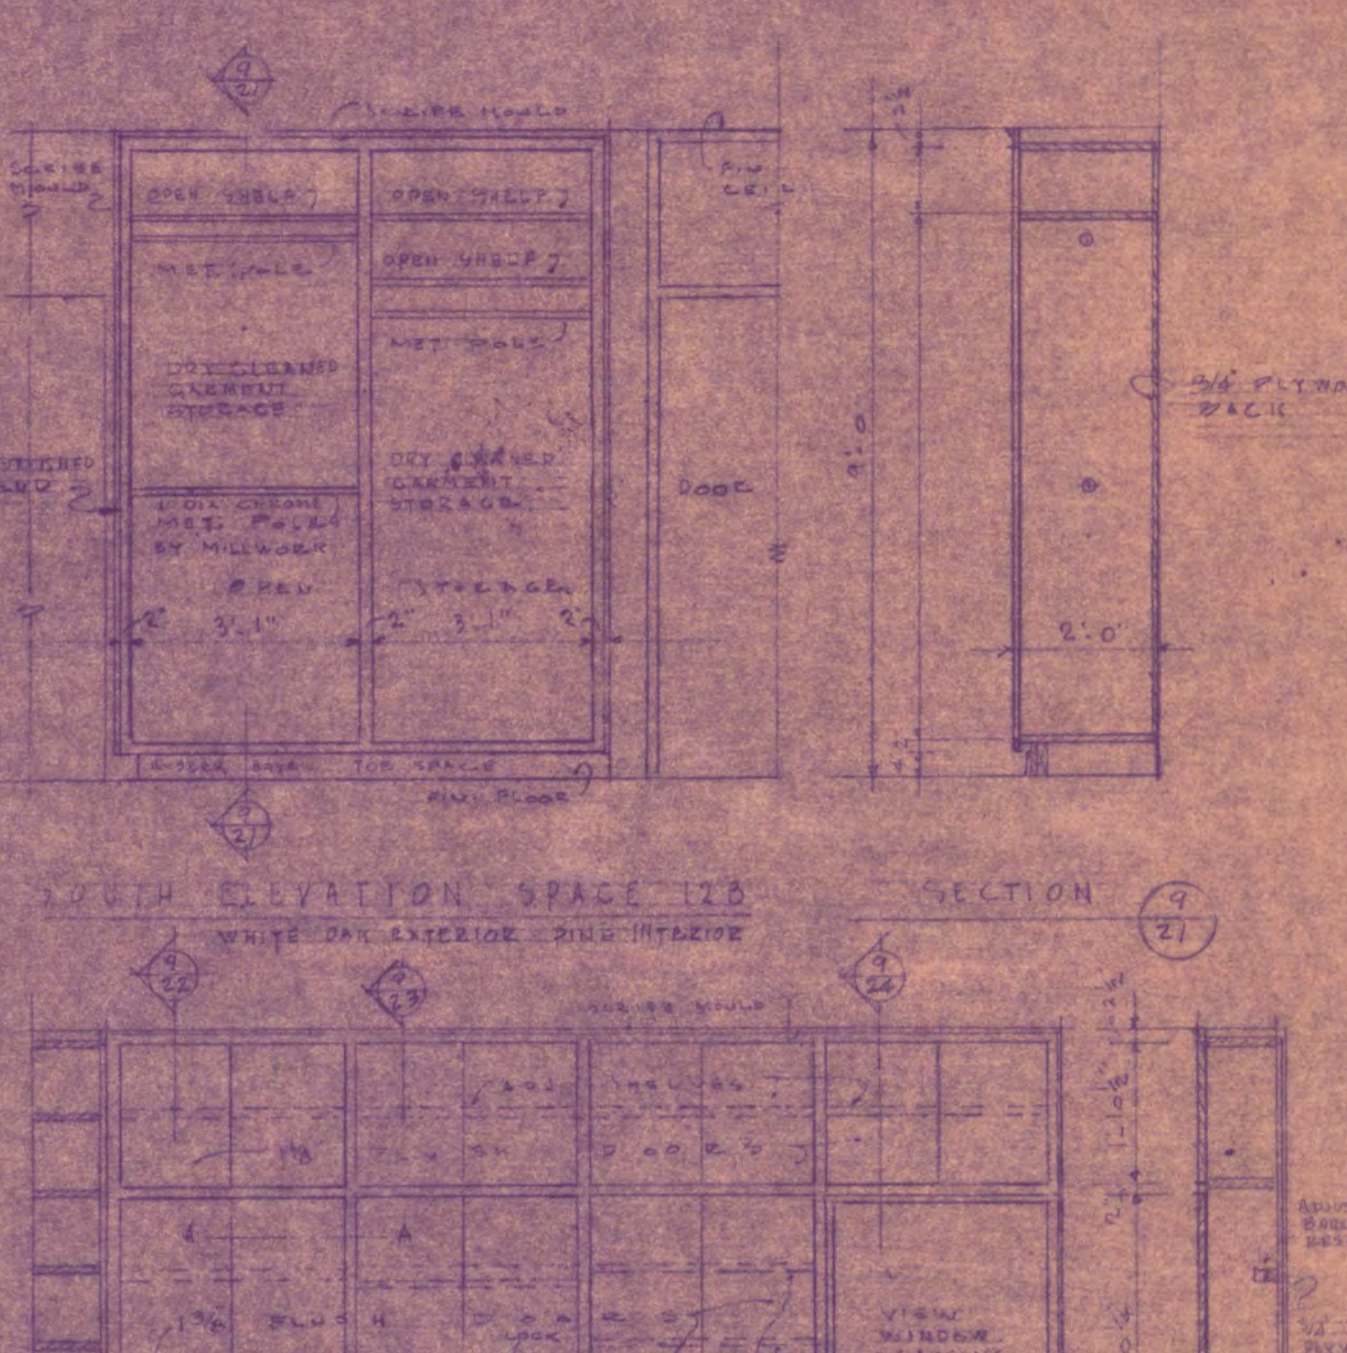


YOUTH ELEVATION SPACE 115  
SCALE 3/8" = 1'-0"

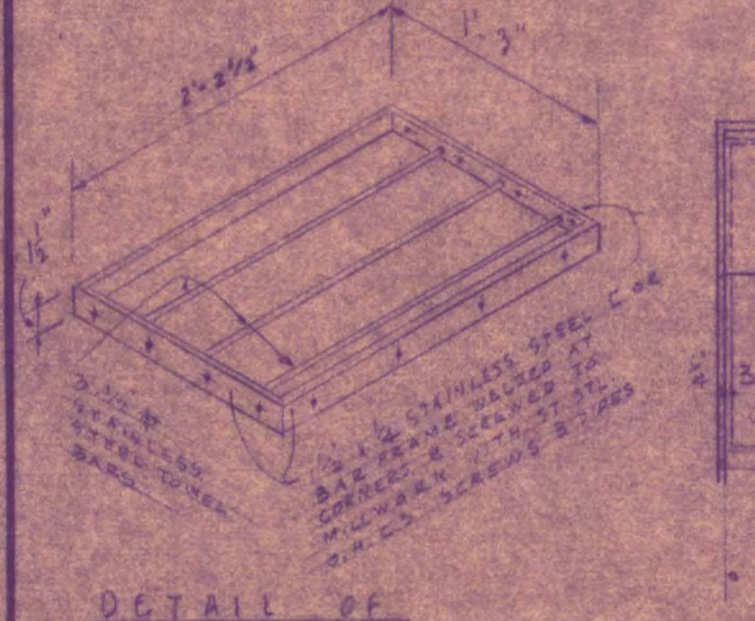


DETAIL OF TOWEL RACK  
SCALE 3/8" = 1'-0"

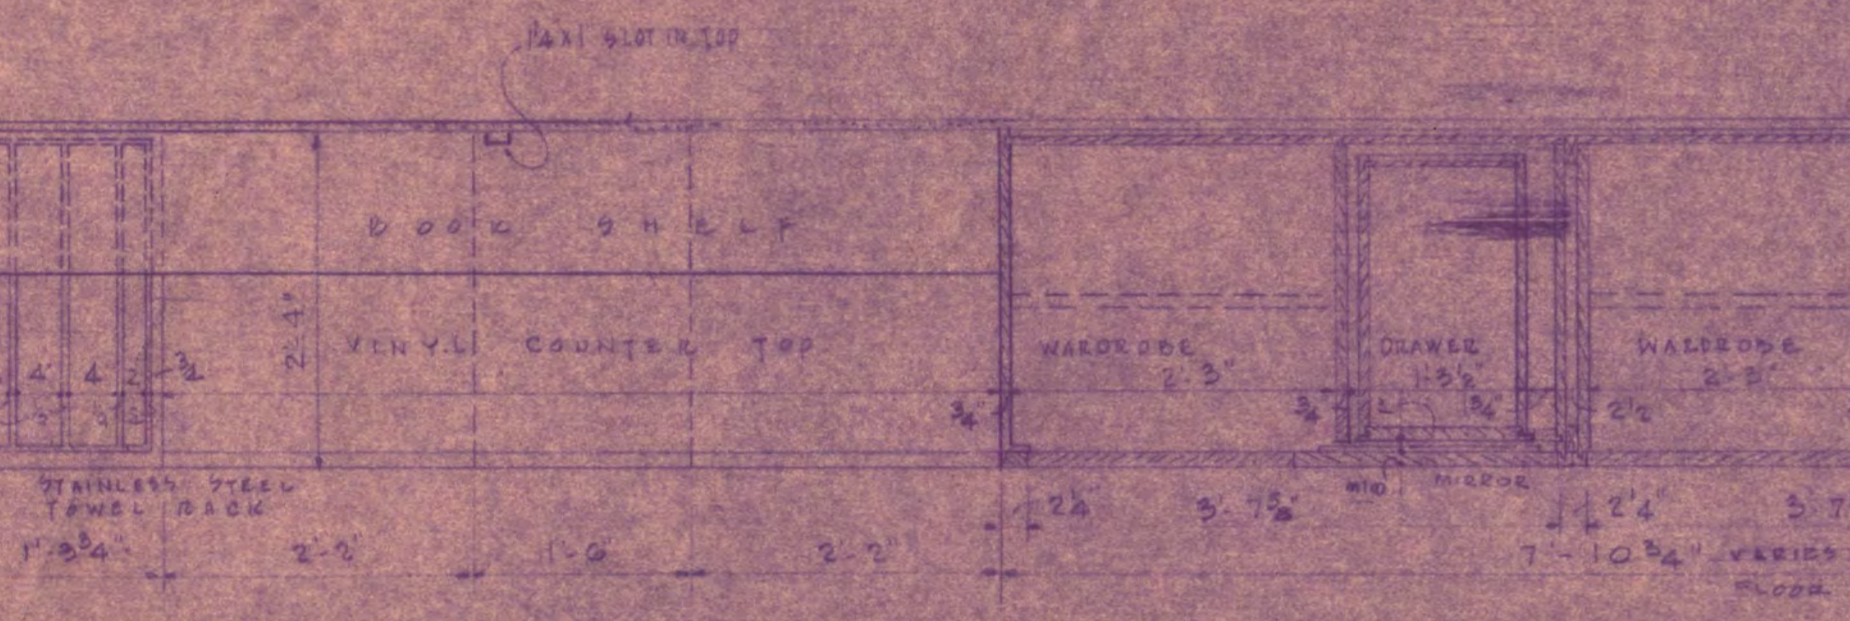

PLAN SECTION - TYPICAL BED ROOM DESK & WARDROBE  
SCALE 3/8" = 1'-0"

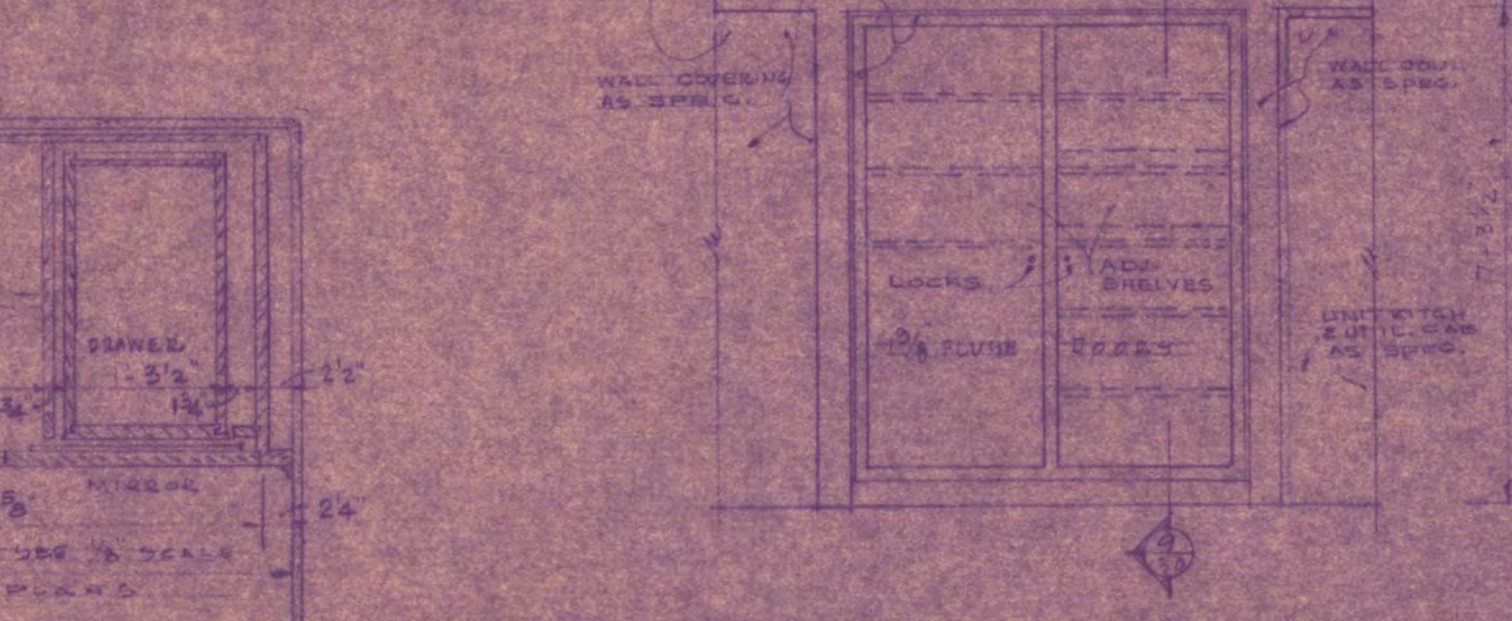


ELEVATION - CUPB'D STORAGE CABINET RECREATION RM. SPACE 121  
SCALE 3/8" = 1'-0"

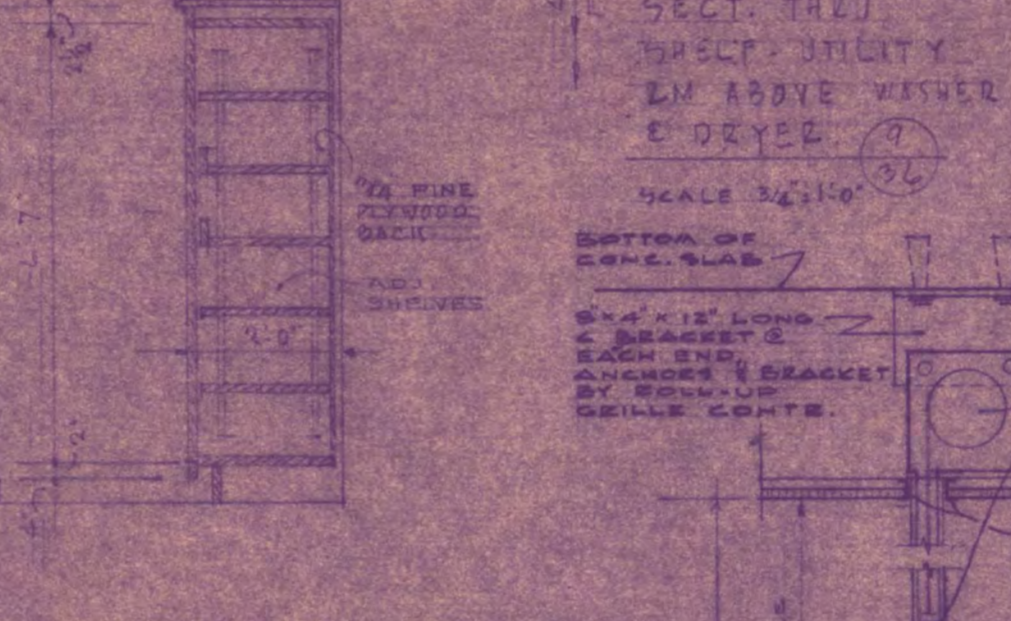


ELEVATION - CUPB'D STORAGE CABINET RECREATION RM. SPACE 121  
SCALE 3/8" = 1'-0"




YOUTH ELEVATION - SPACE 115  
SCALE 3/8" = 1'-0"

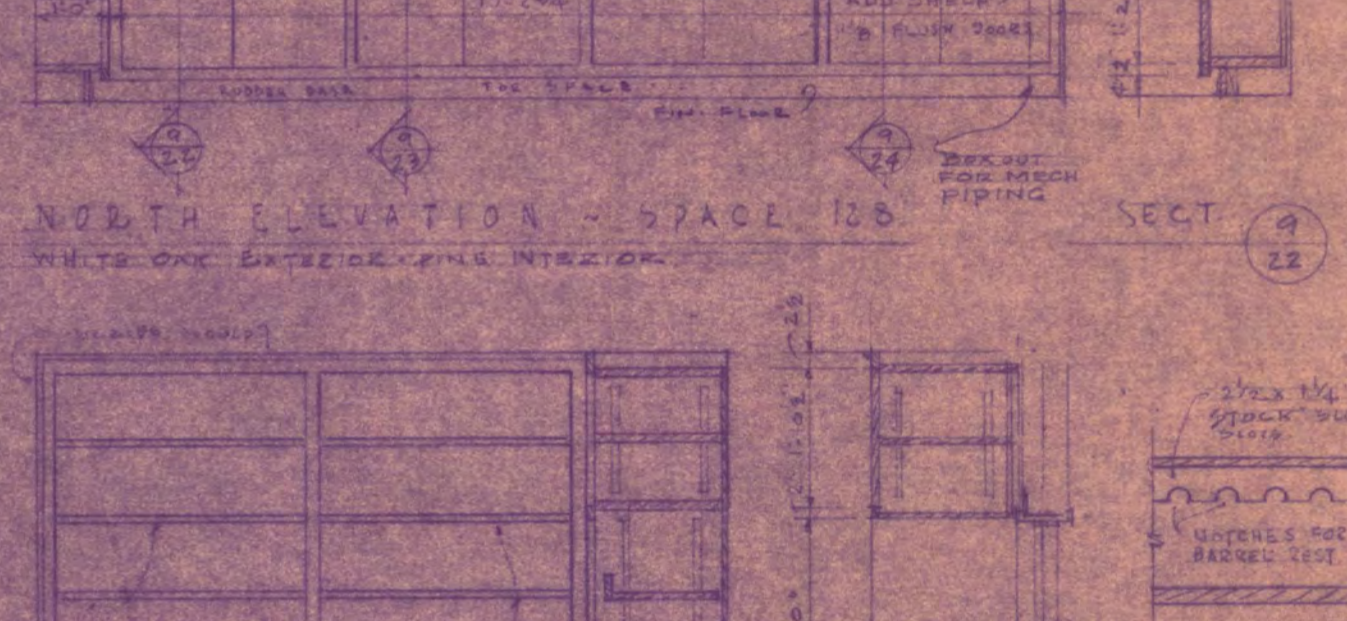


YOUTH ELEVATION - SPACE 115  
SCALE 3/8" = 1'-0"

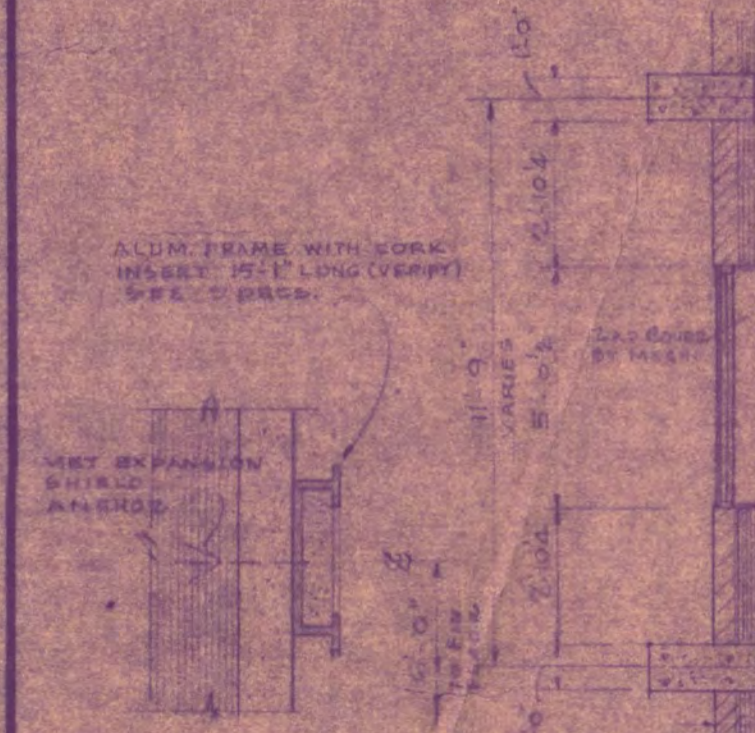


VERTICAL SECT. LINEN CLOSET SHELVING  
SCALE 3/8" = 1'-0"

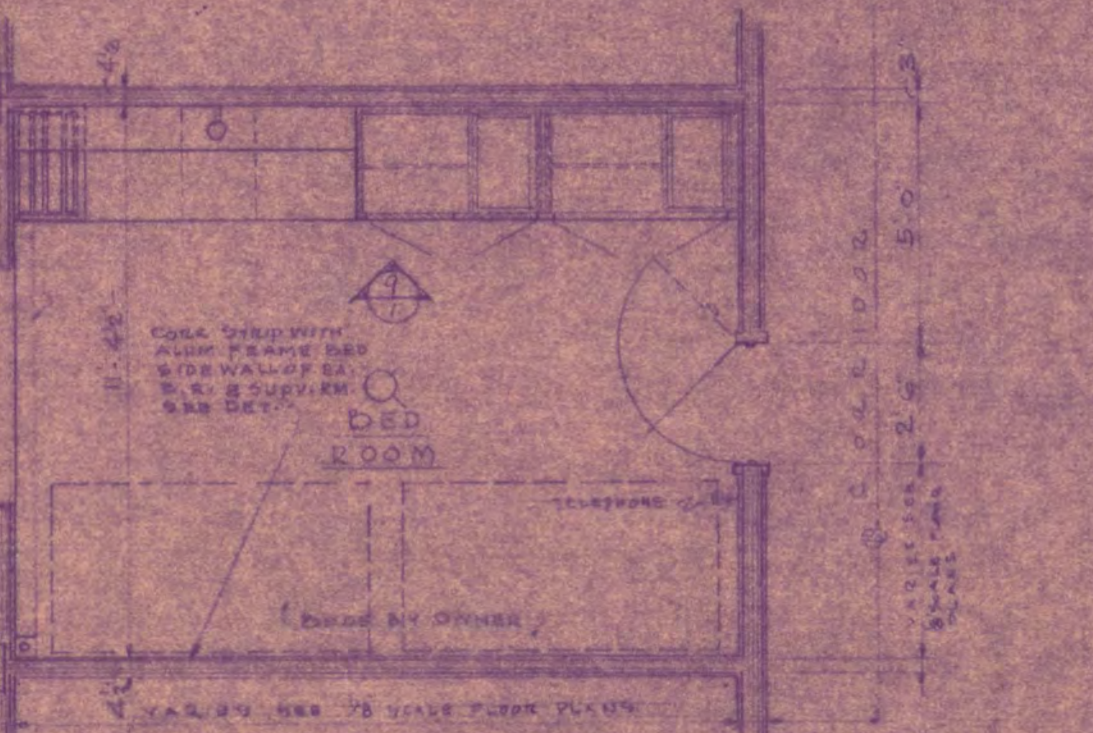


VERTICAL SECT. LINEN CLOSET SHELVING  
SCALE 3/8" = 1'-0"

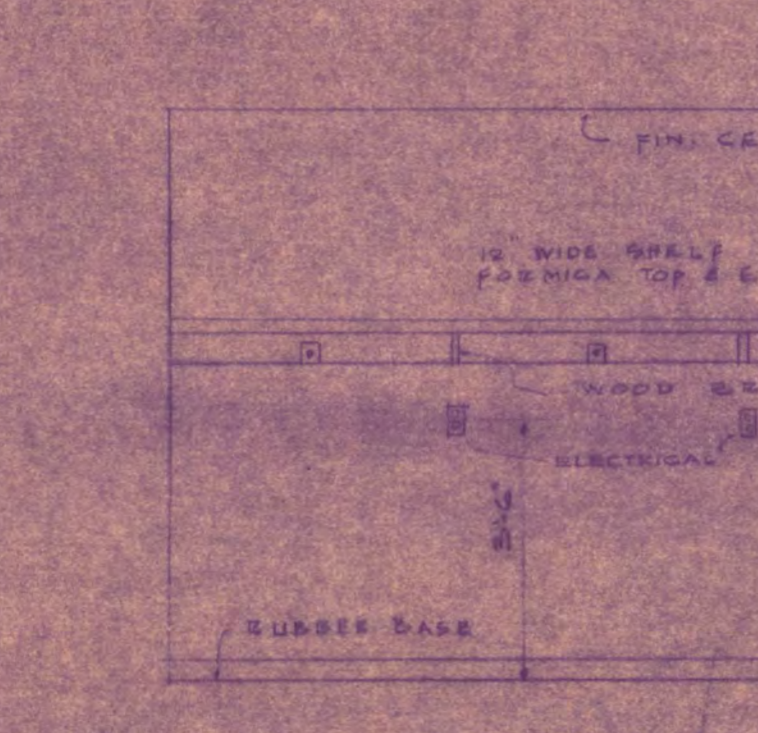


SECTION THRU COUNTER UTILITY RM.  
SCALE 3/8" = 1'-0"

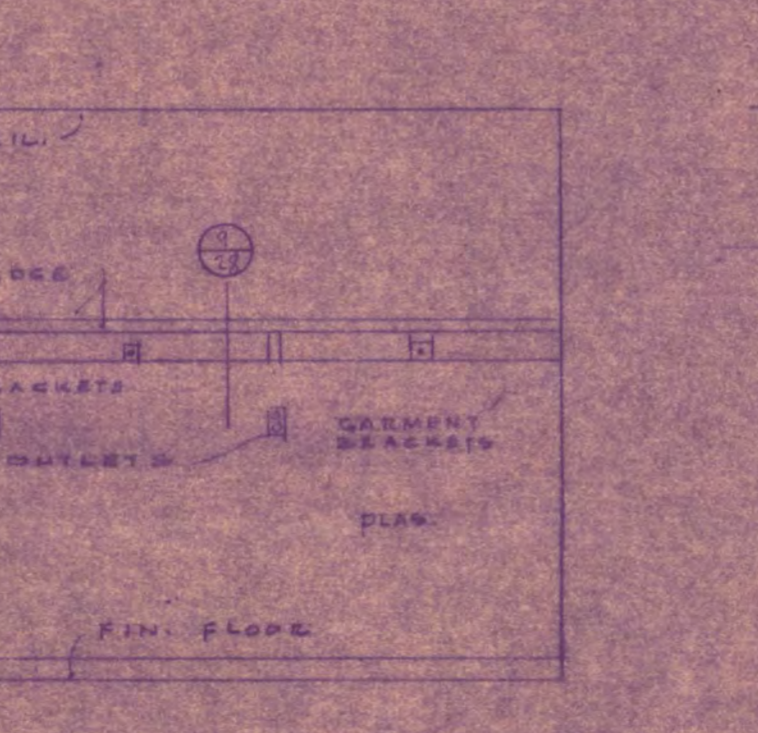


SECTION THRU CABINET UTILITY RM.  
SCALE 3/8" = 1'-0"

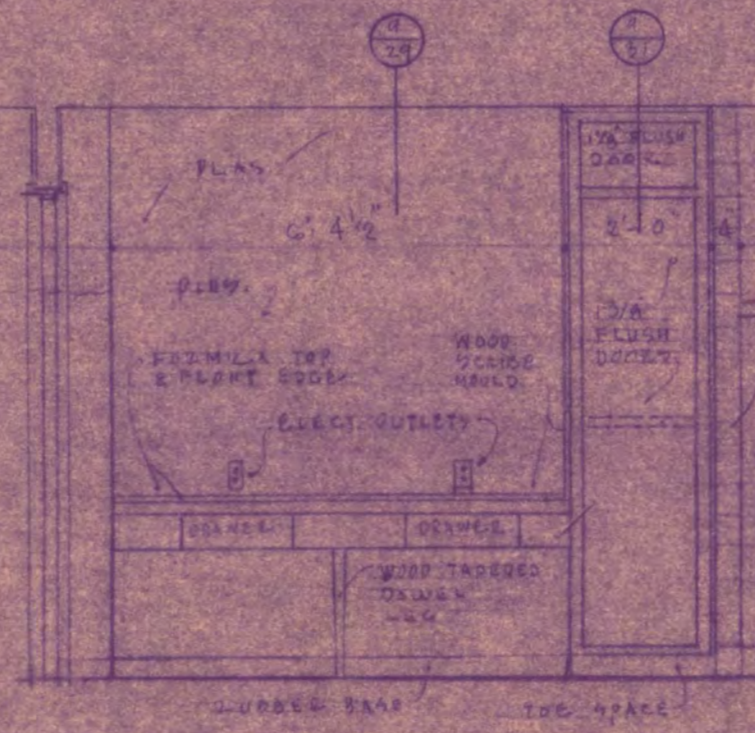


SECTION THRU CABINET UTILITY RM.  
SCALE 3/8" = 1'-0"

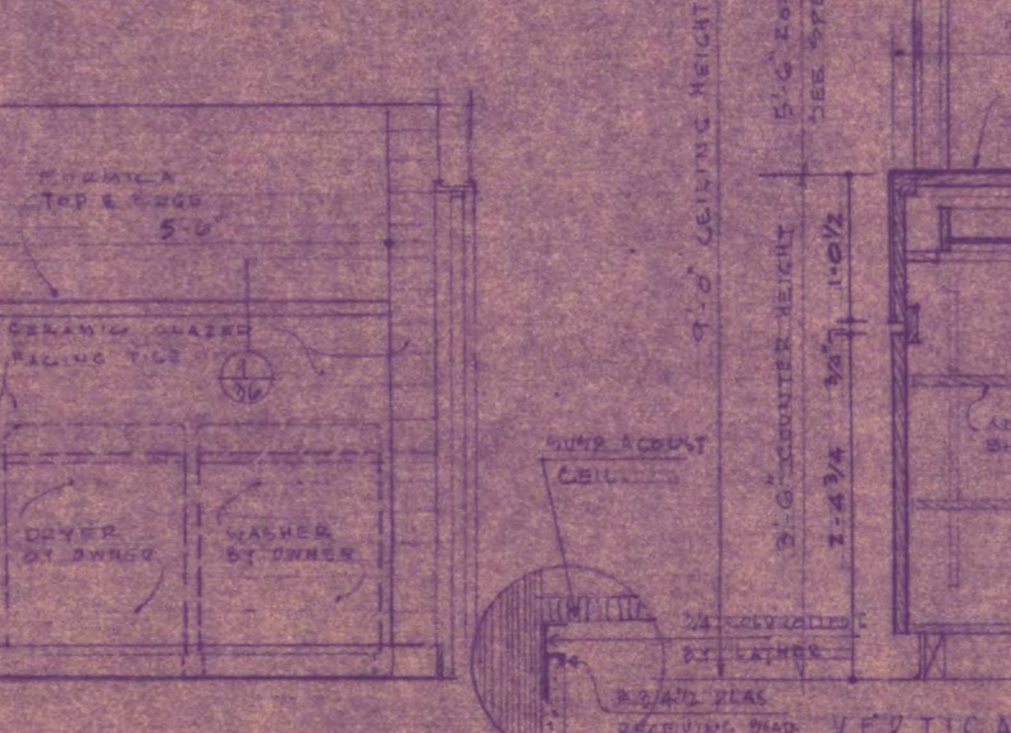


SECTION THRU CABINET UTILITY RM.  
SCALE 3/8" = 1'-0"

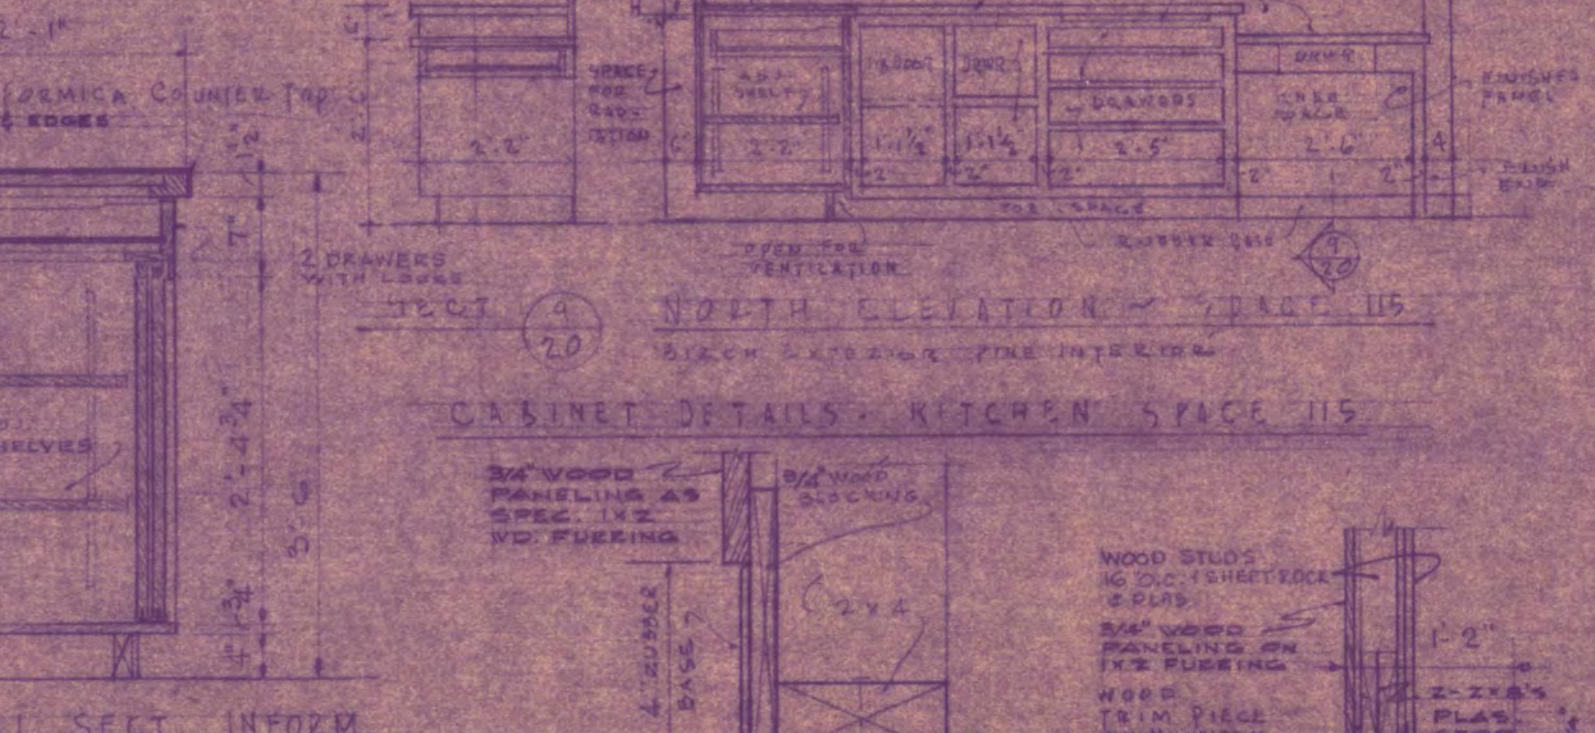


SECTION THRU CABINET UTILITY RM.  
SCALE 3/8" = 1'-0"

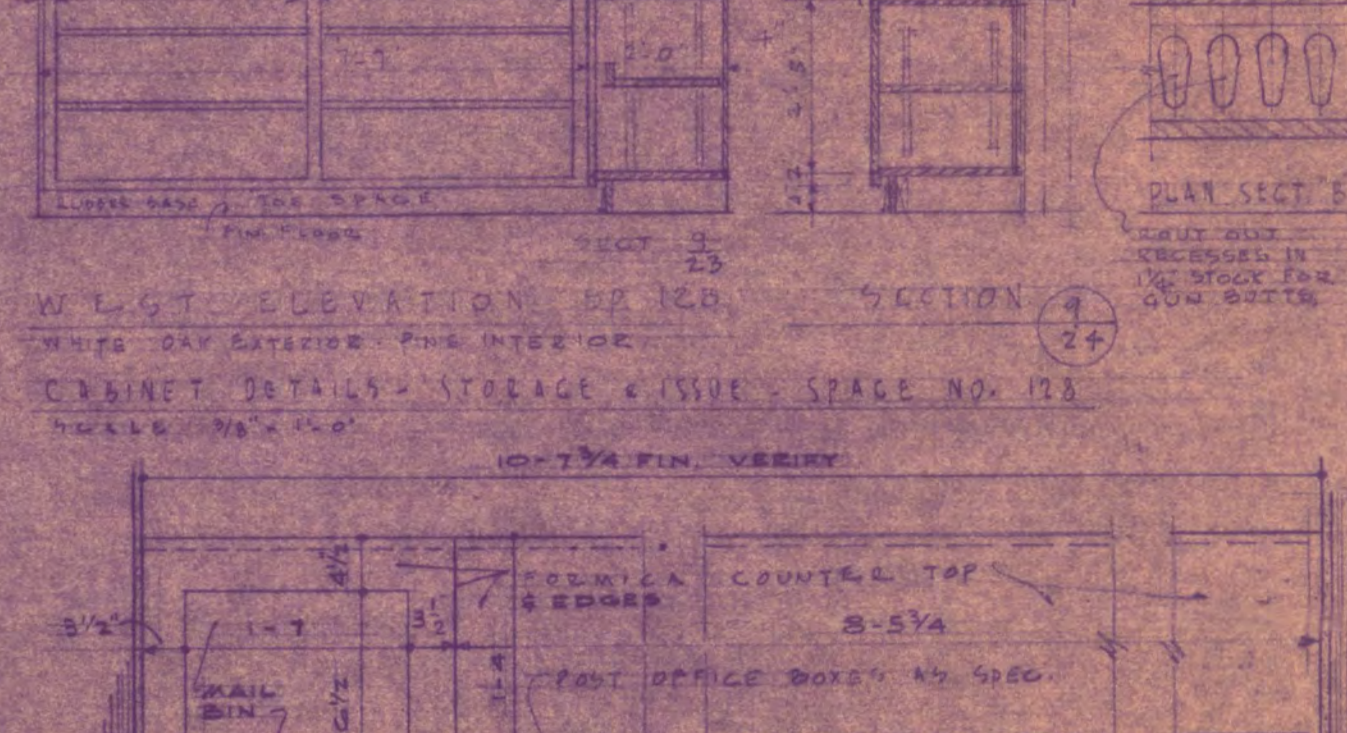


SECTION THRU CABINET UTILITY RM.  
SCALE 3/8" = 1'-0"

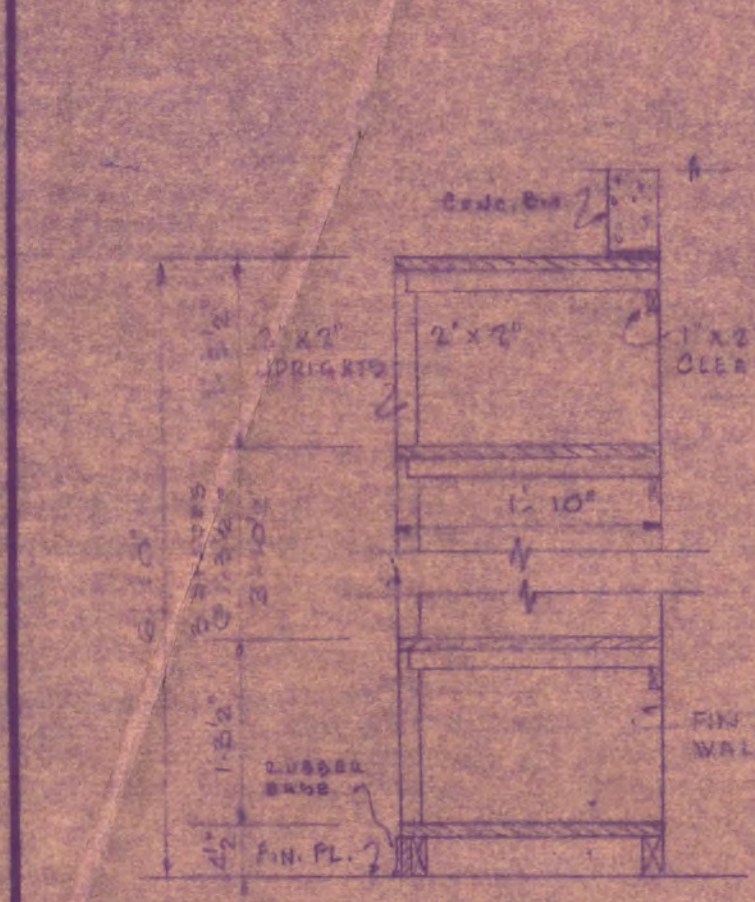


SECTION THRU COUNTER UTILITY RM.  
SCALE 3/8" = 1'-0"

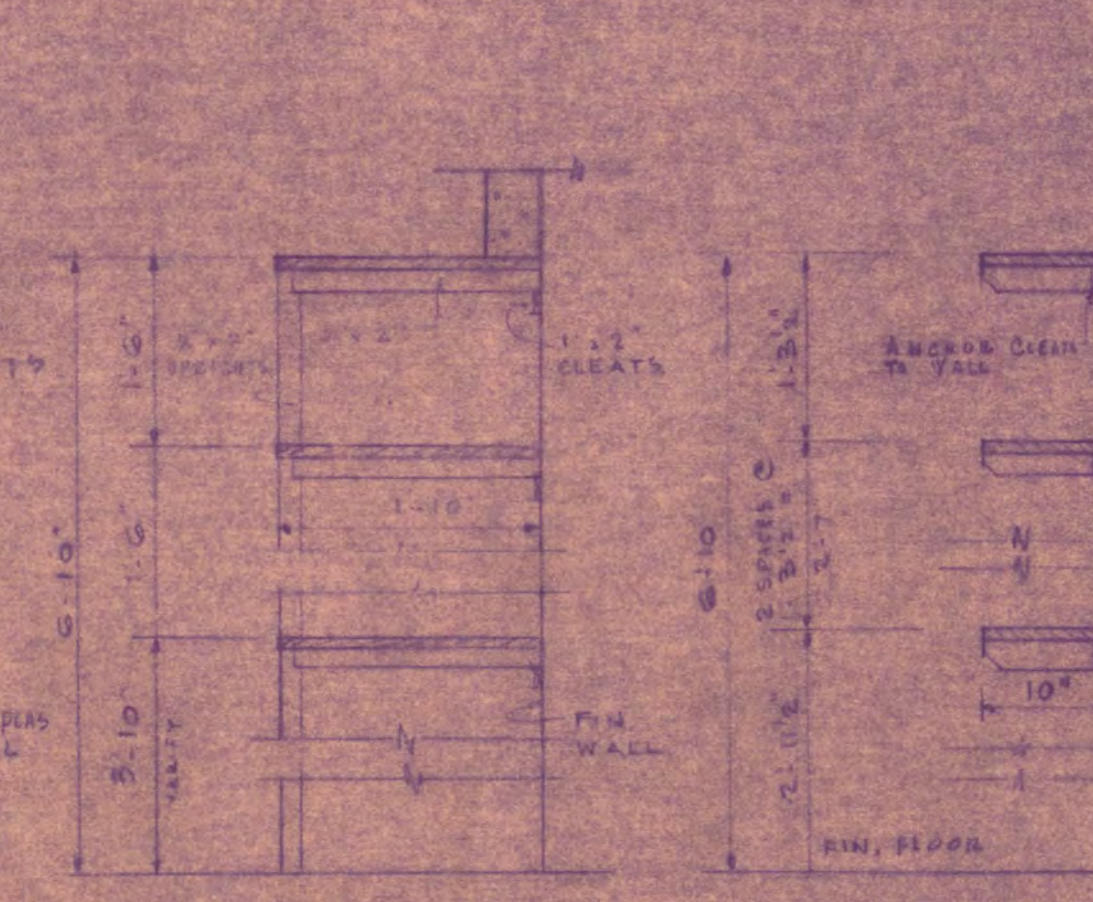


SECTION THRU CABINET UTILITY RM.  
SCALE 3/8" = 1'-0"

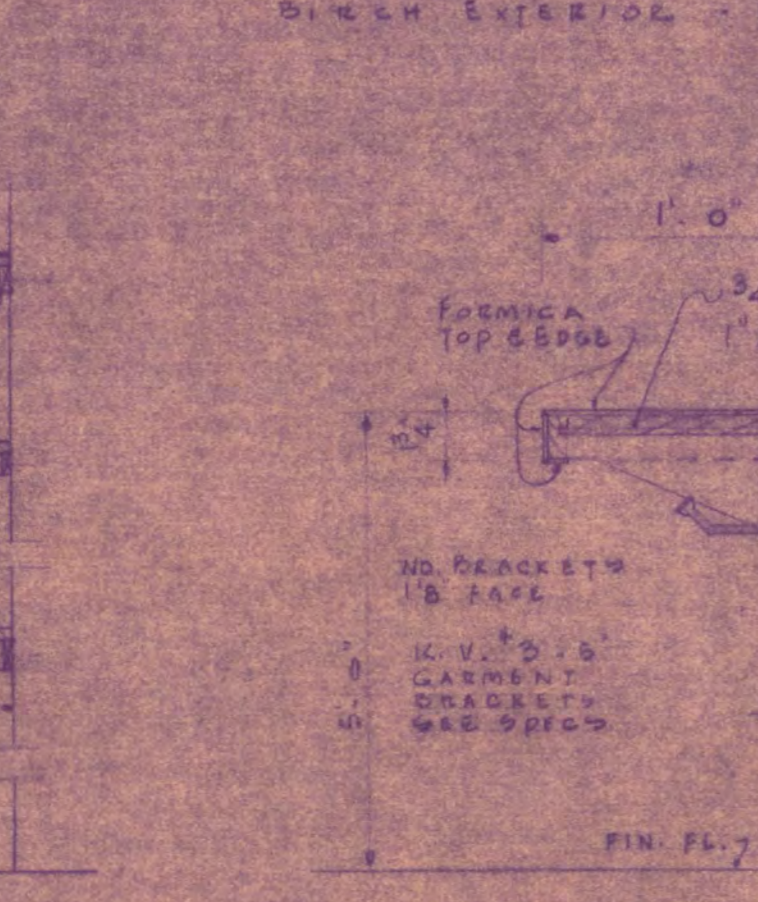


SECTION THRU CABINET UTILITY RM.  
SCALE 3/8" = 1'-0"

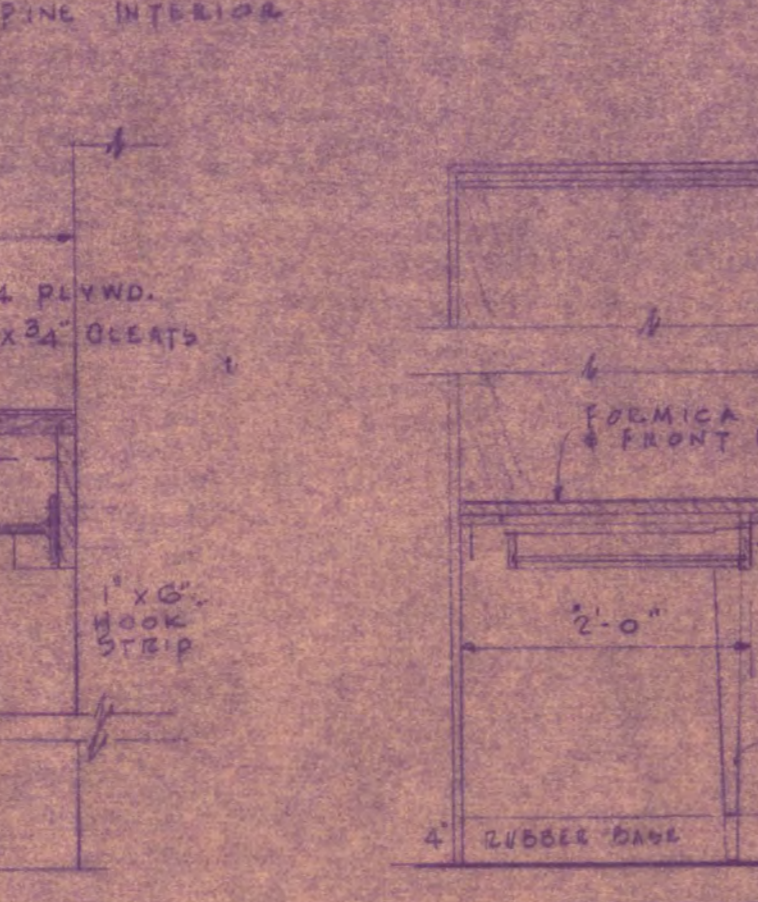


SECTION THRU CABINET UTILITY RM.  
SCALE 3/8" = 1'-0"

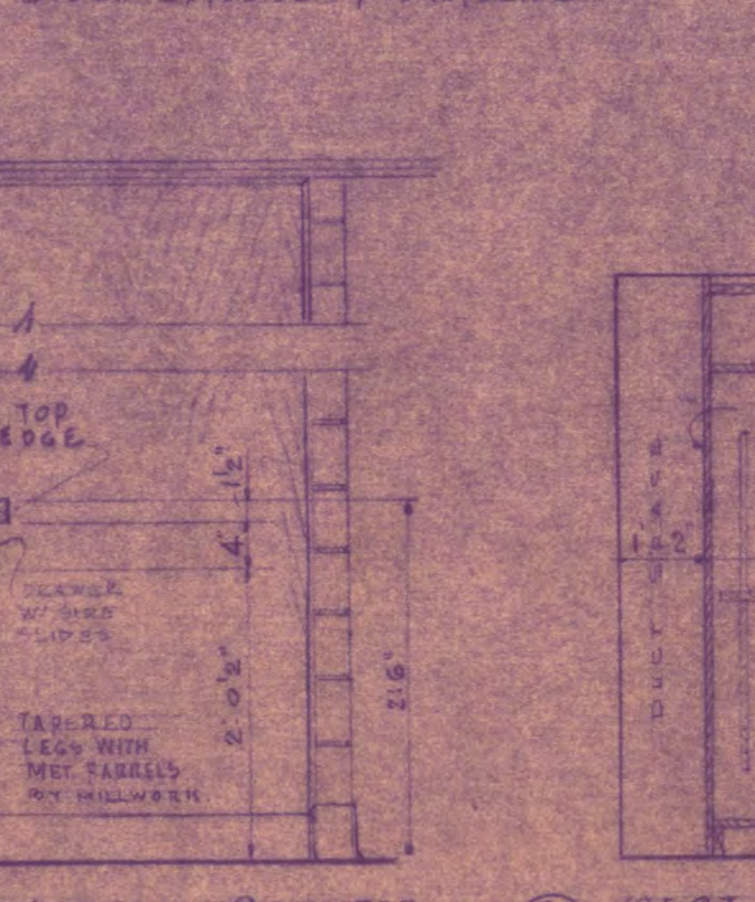


SECTION THRU CABINET UTILITY RM.  
SCALE 3/8" = 1'-0"

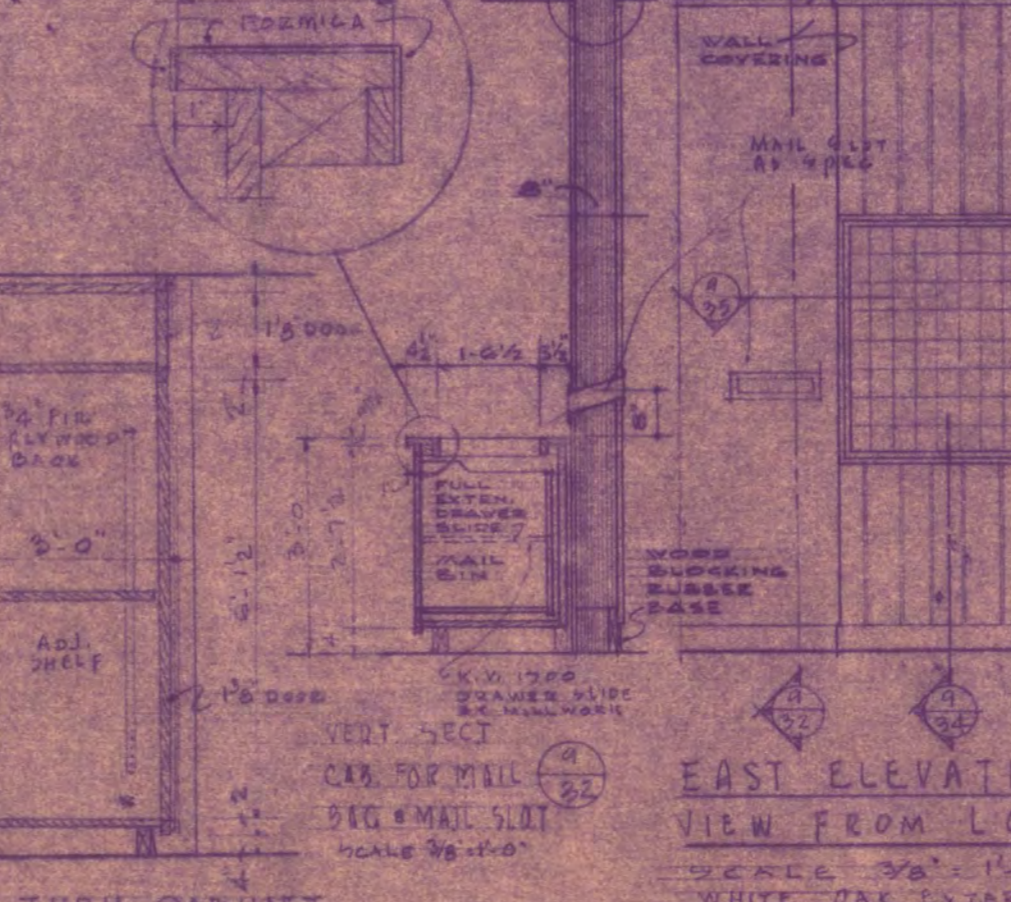

SECTION THRU CABINET UTILITY RM.  
SCALE 3/8" = 1'-0"

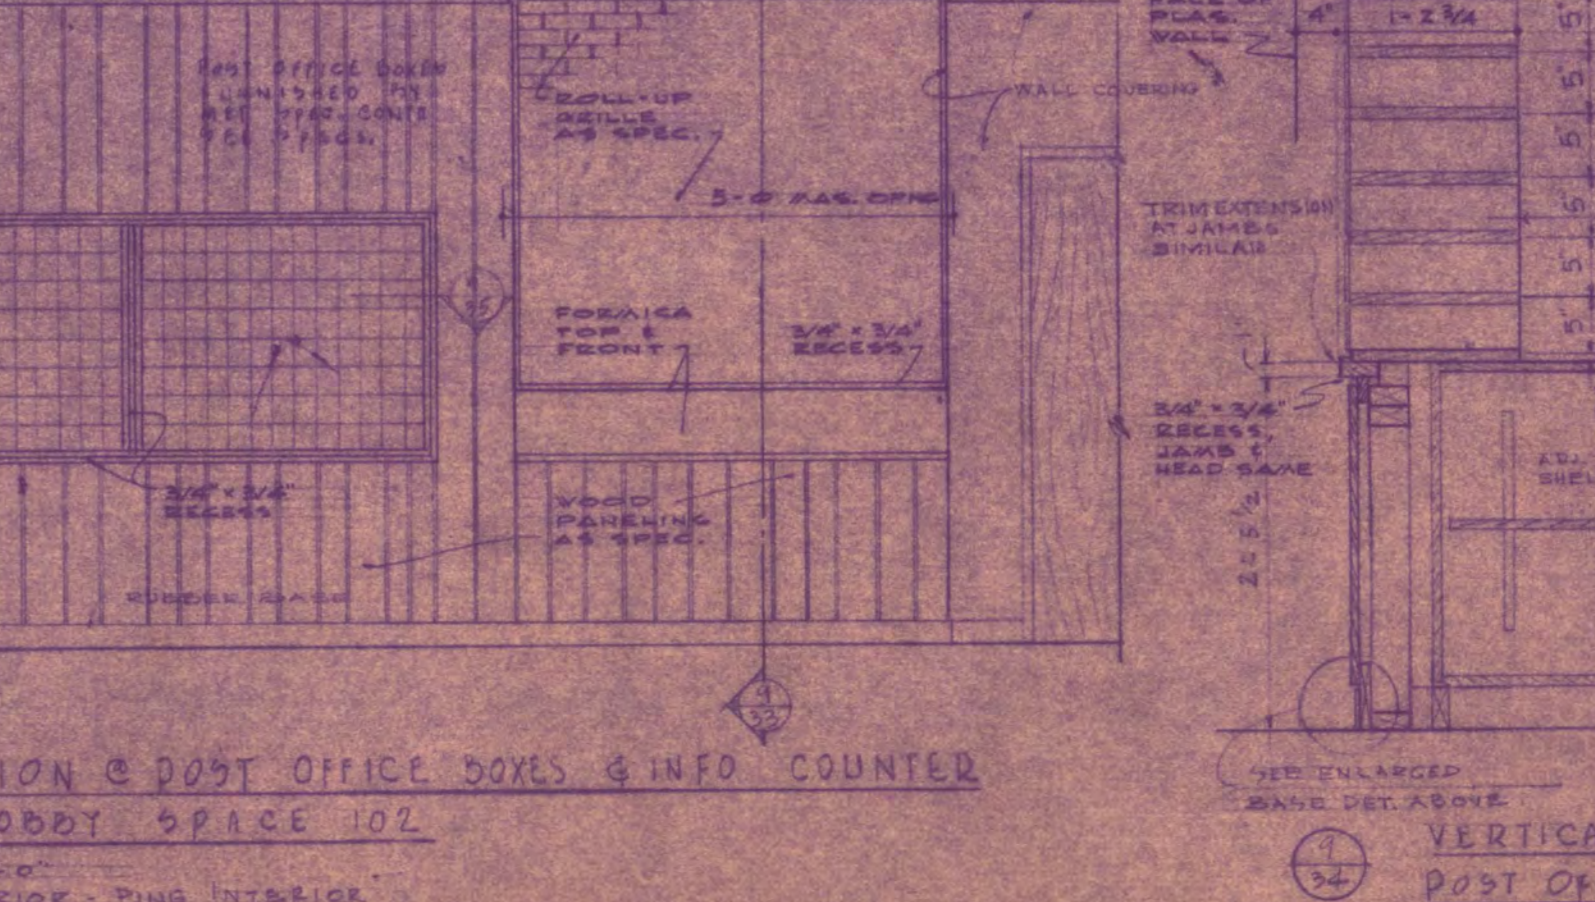


SECTION THRU CABINET UTILITY RM.  
SCALE 3/8" = 1'-0"

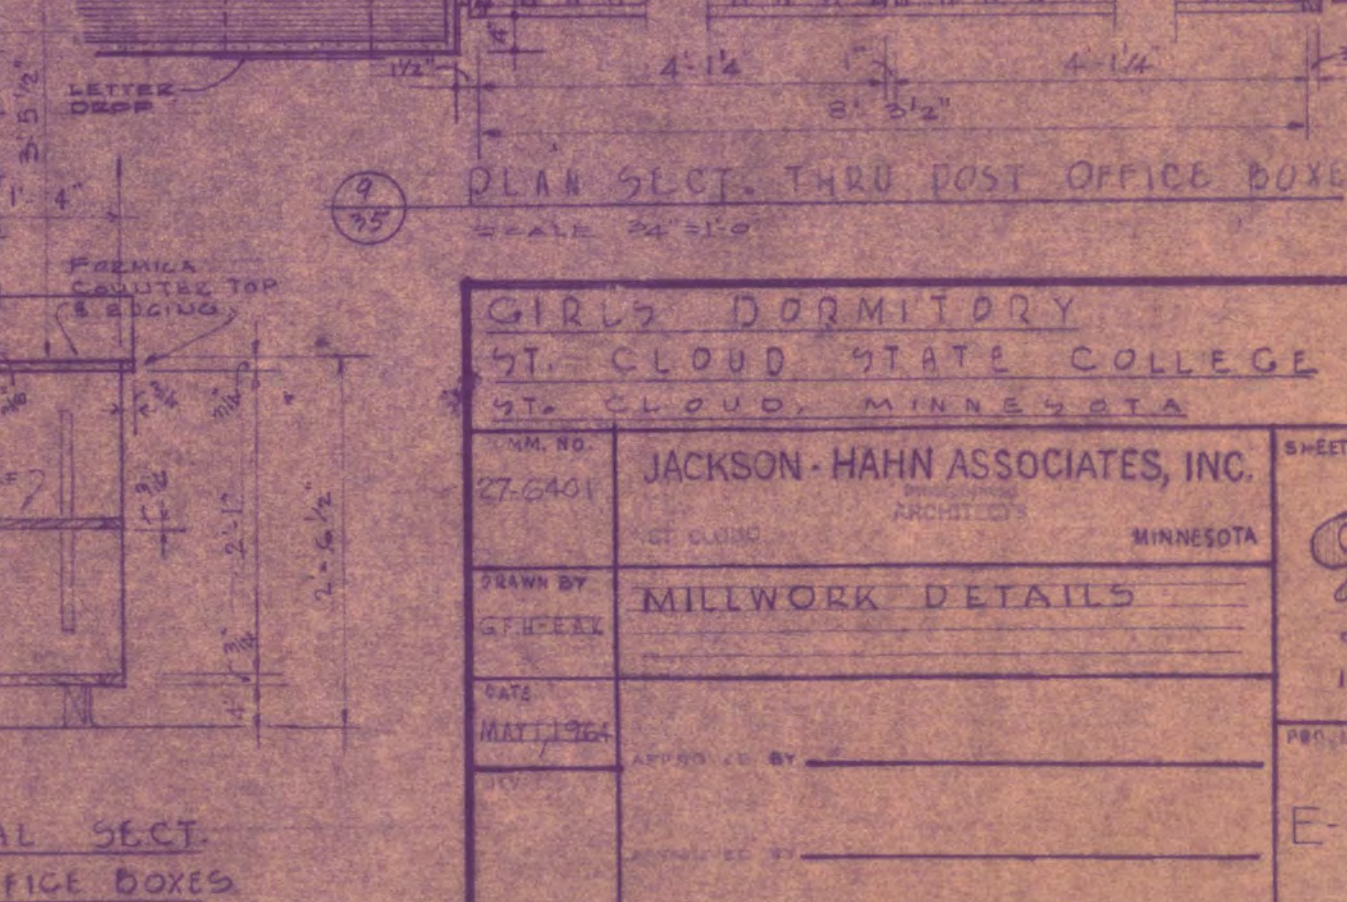




SECTION THRU CABINET UTILITY RM.  
SCALE 3/8" = 1'-0"

GIRLS' DORMITORY ST. CLOUD STATE COLLEGE ST. CLOUD, MINNESOTA	
DESIGNED BY	JACKSON-HAHN ASSOCIATES, INC. MINNESOTA
DRAWN BY	MILLWORK DETAILS
DATE	
SCALE	
PROJECT NO.	
SHEET NO.	9
TOTAL SHEETS	10
DATE	



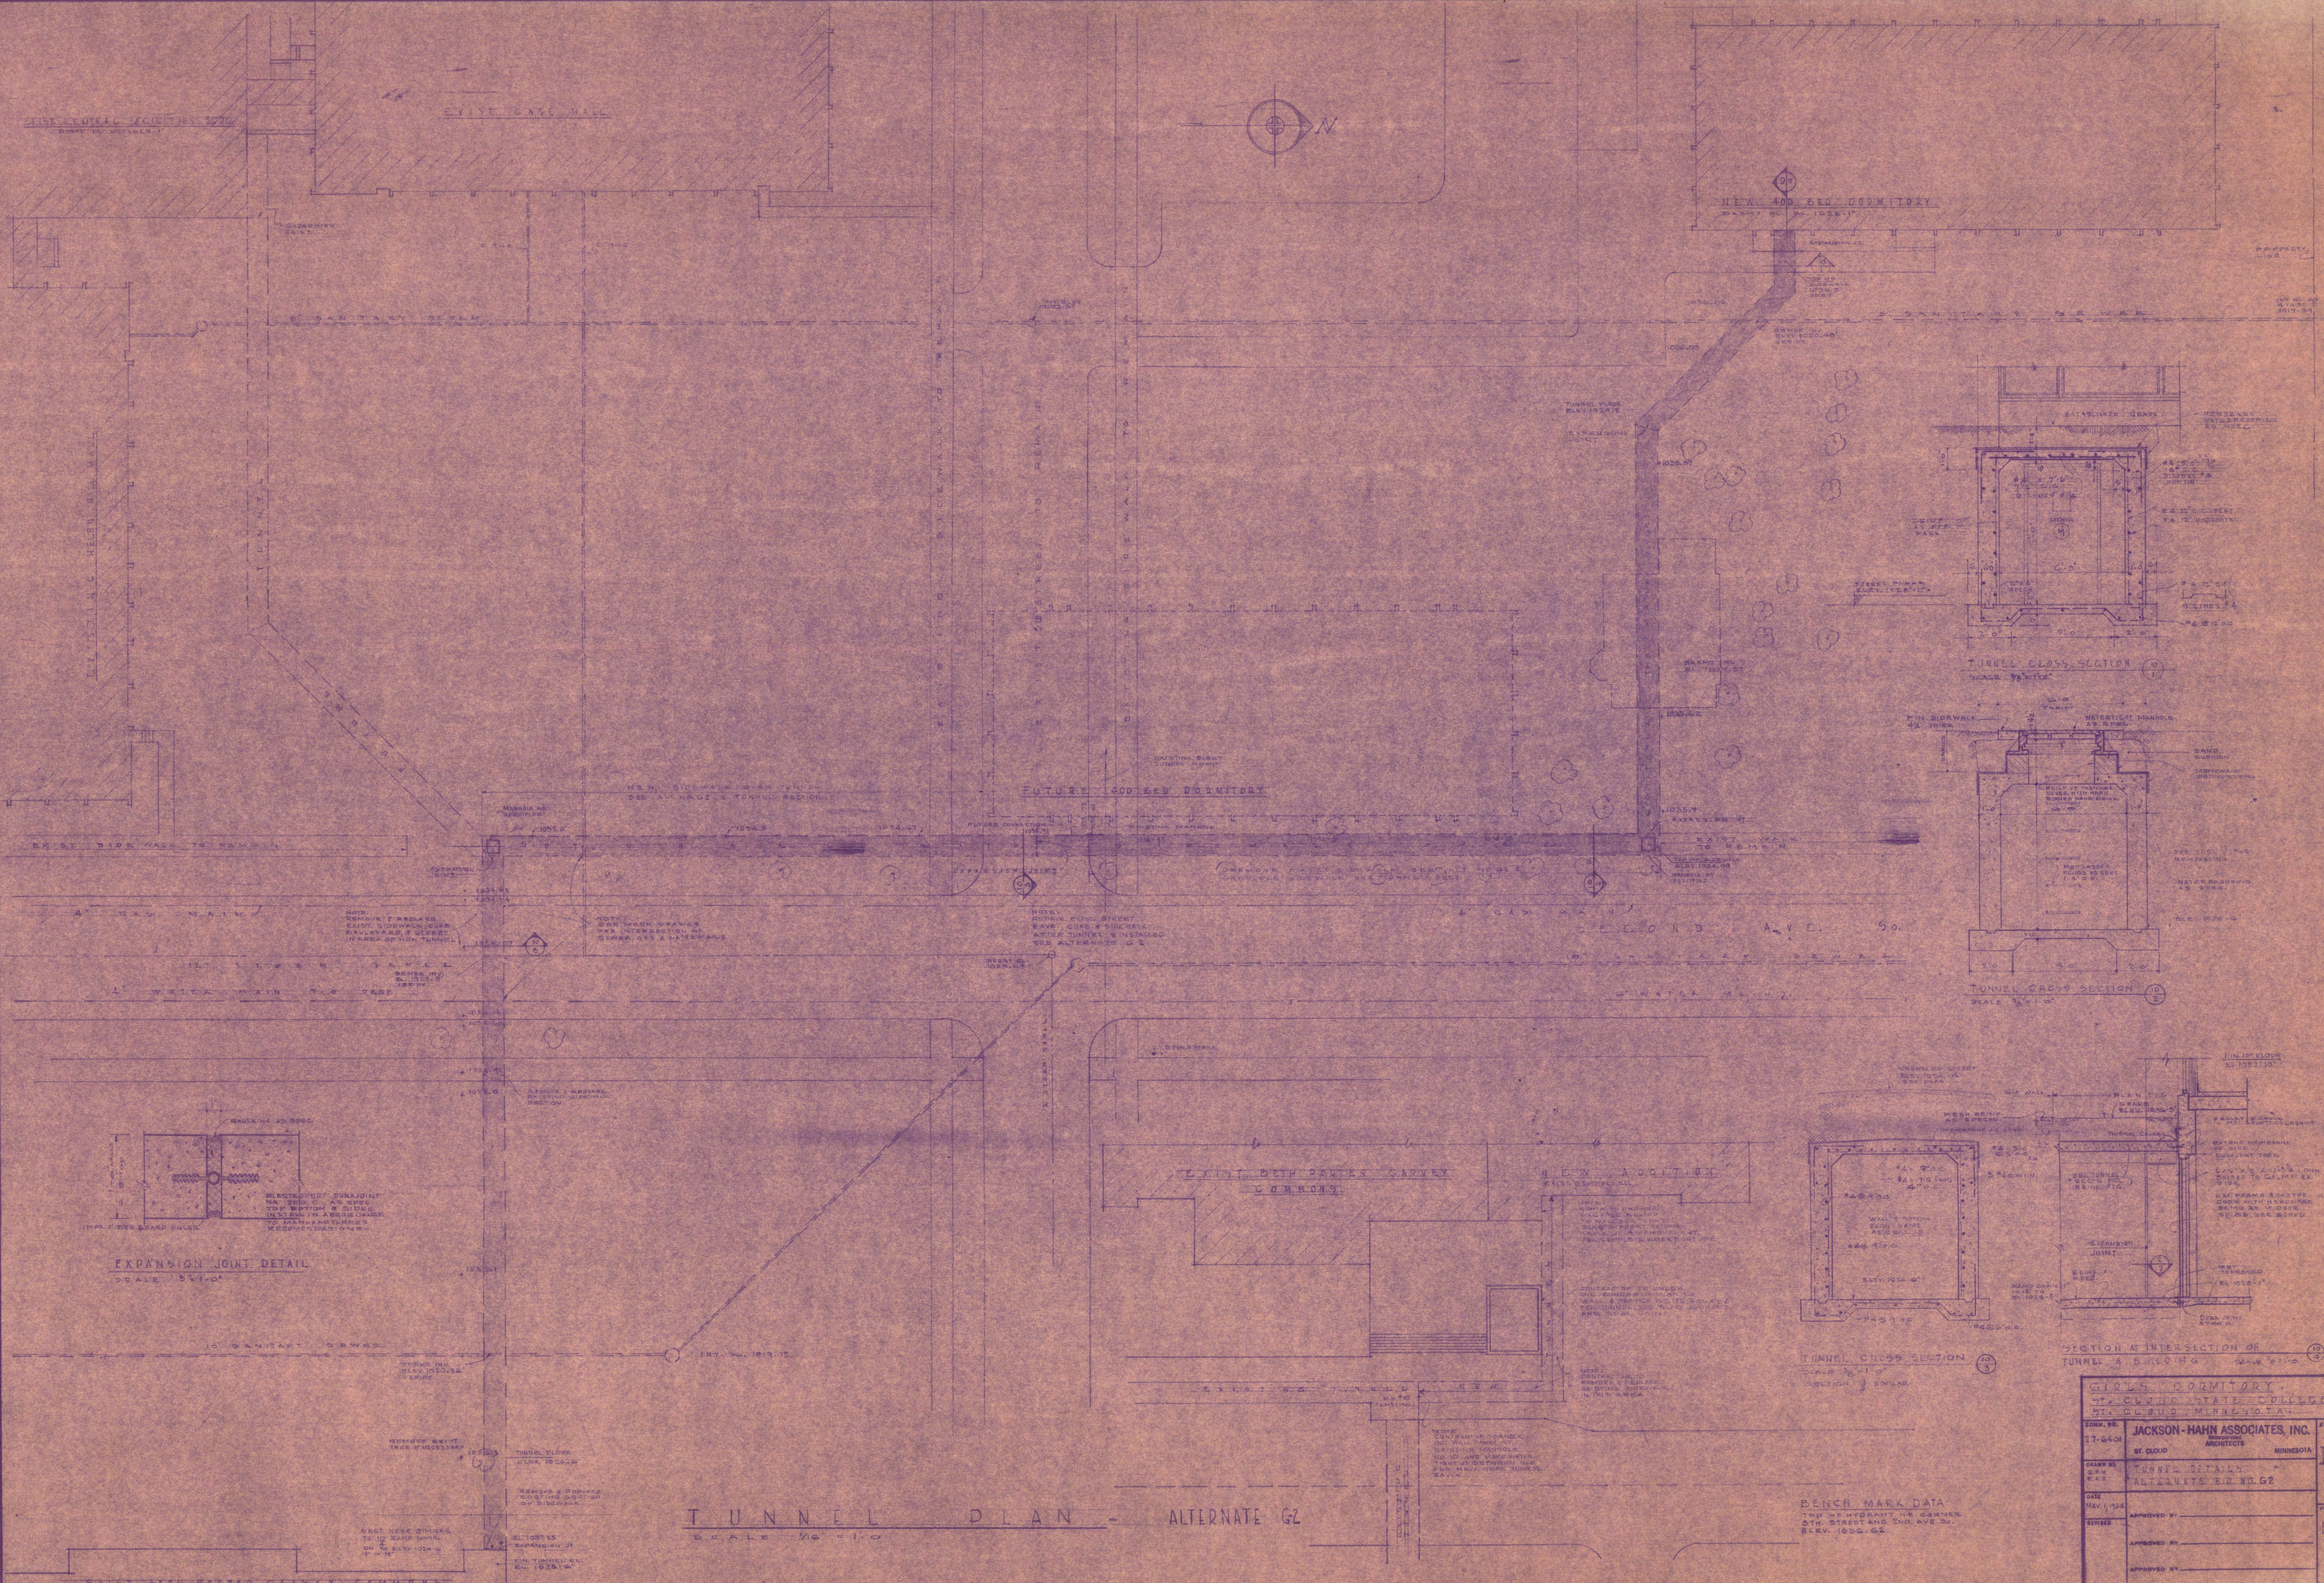


TUNNEL PLAN - ALTERNATE G2  
SCALE 1/8" = 1'-0"

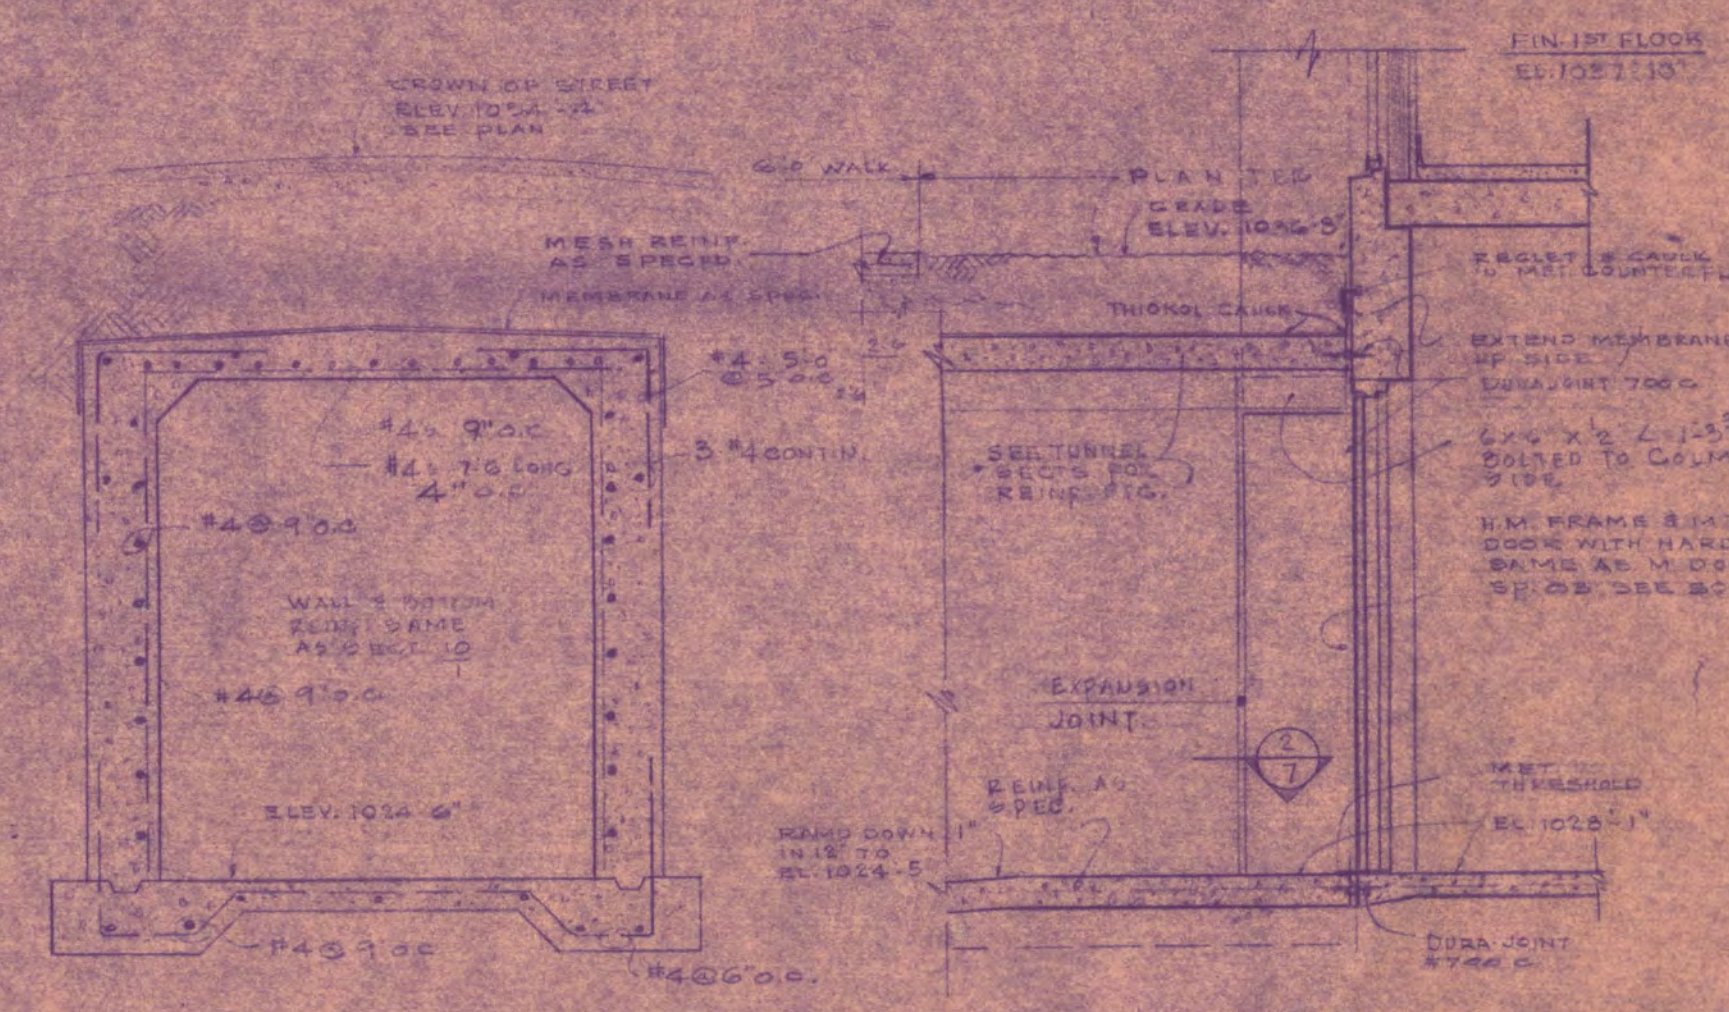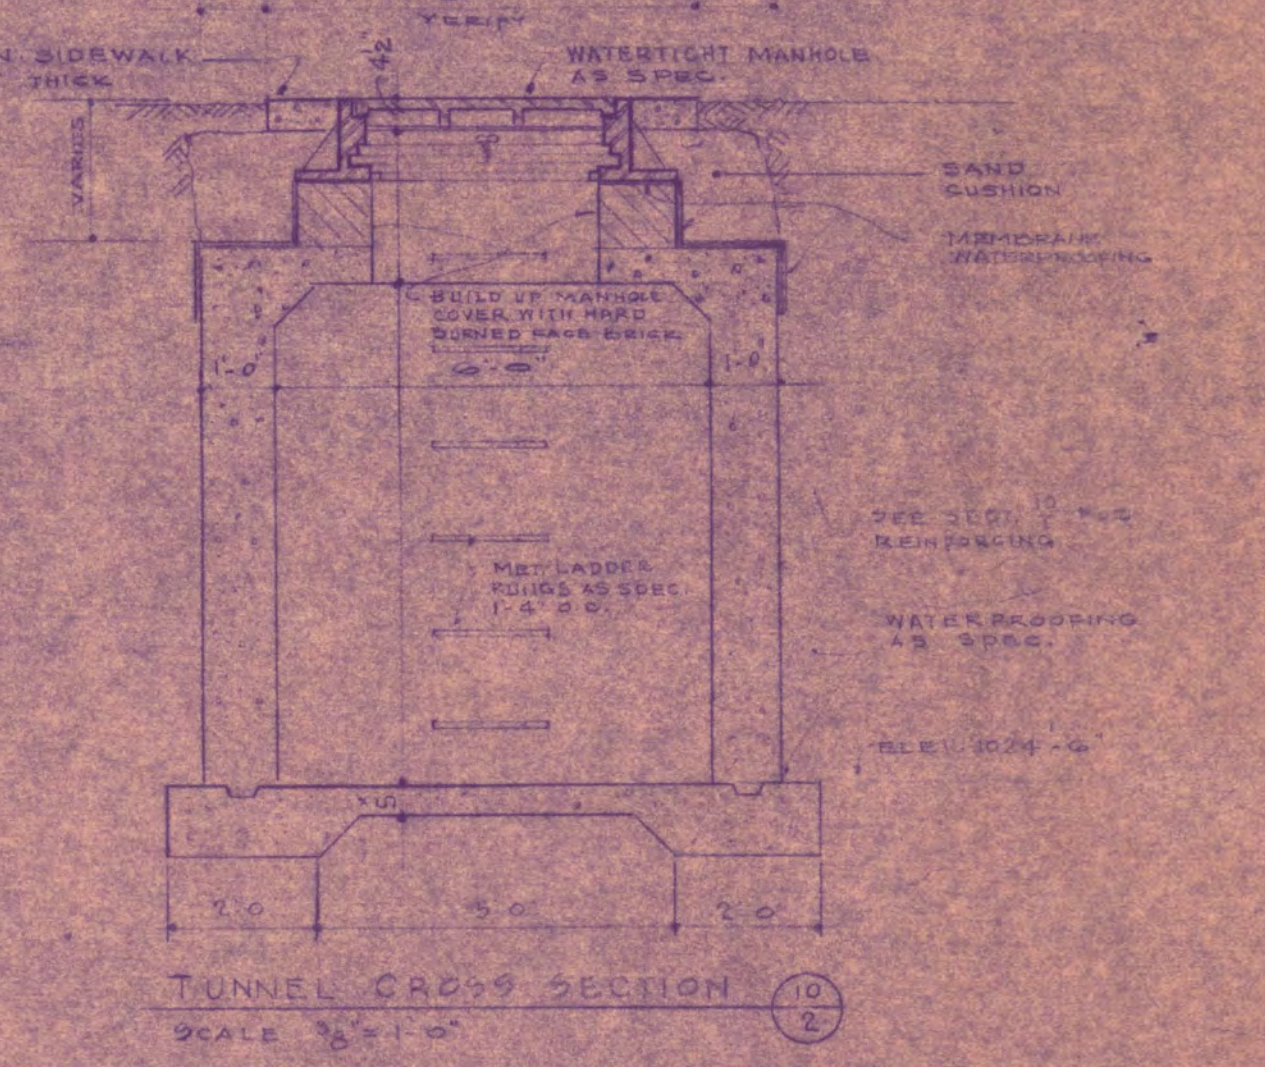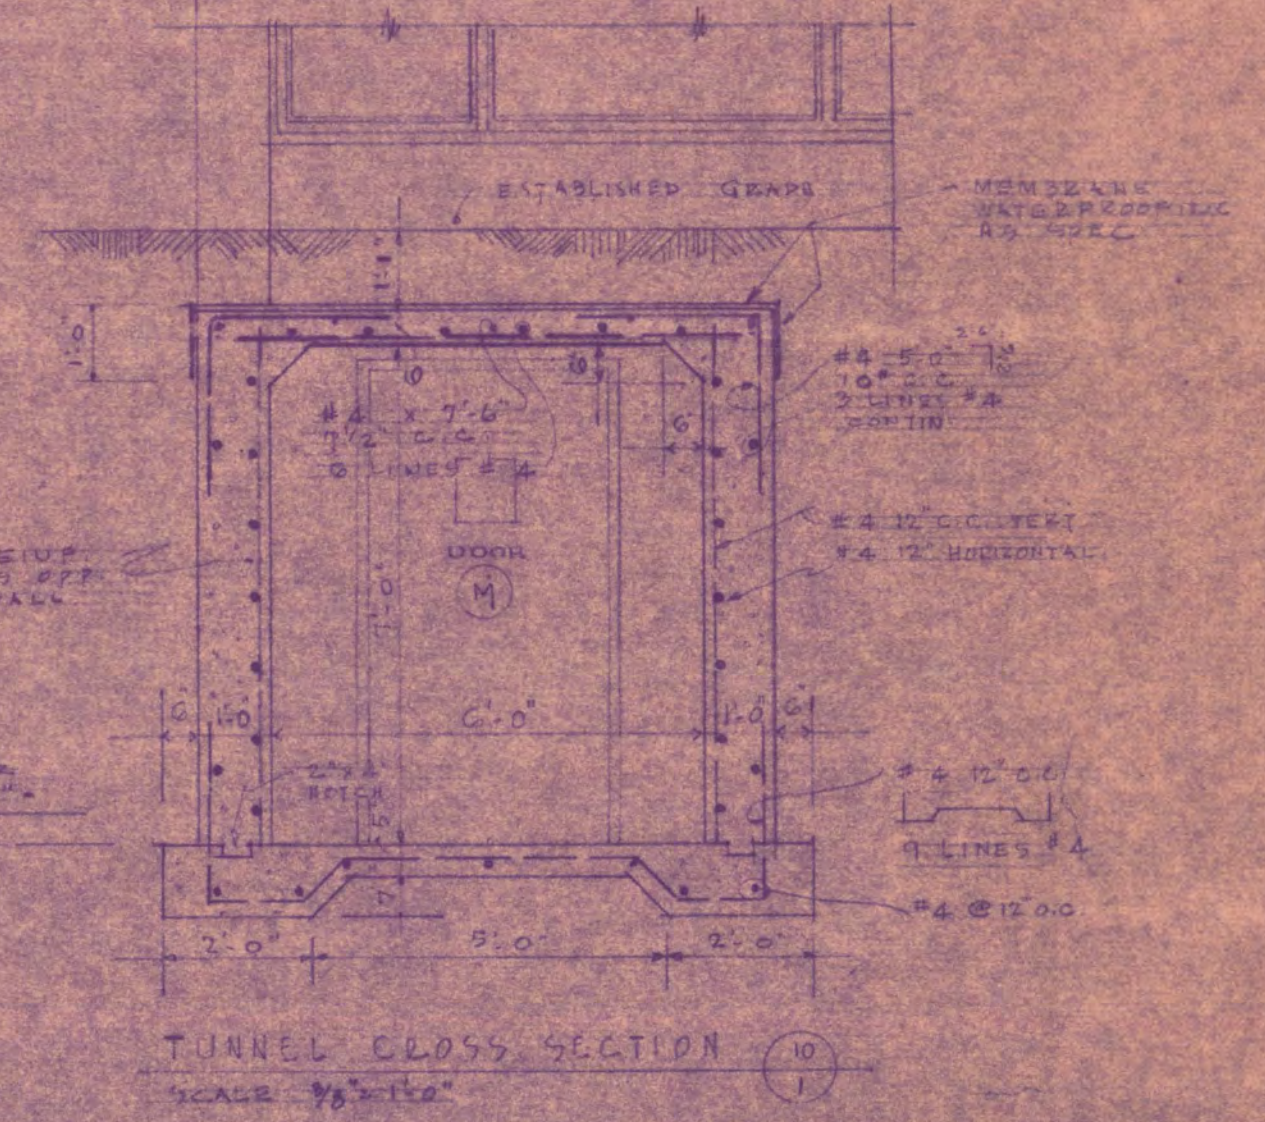

TUNNEL CROSS SECTION (3)  
SCALE 1/8" = 1'-0"

SECTION AT INTERSECTION OF TUNNEL & BELLONG  
SCALE 1/8" = 1'-0"

EXPANSION JOINT DETAIL  
SCALE 3/4" = 1'-0"

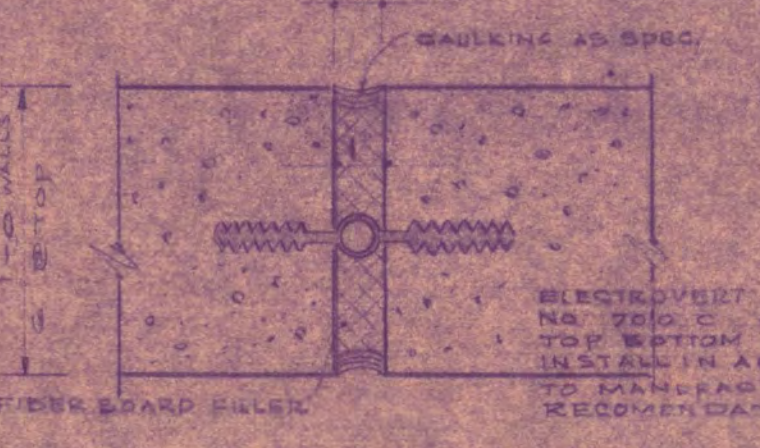

GIRLS' DORMITORY ST. CLOUD STATE COLLEGE ST. CLOUD, MINNESOTA		
FORM NO. 27-64-01	JACKSON-HAHN ASSOCIATES, INC. ARCHITECTS ST. CLOUD, MINNESOTA	SHEET NO. 10
DRAWN BY E.A.R.	BY CLOUD	OF 10
DATE MAY 1, 1926	TUNNEL DETAILS ALTERNATE G2 NO. G2	PROJECT NO. E-1A
REVISION	APPROVED BY	
	APPROVED BY	
	APPROVED BY	

BENCH MARK DATA  
TOP OF STAIRWAY, NE CORNER  
3TH STREET AND 2ND AVE. SO.  
ELEV. 1026.62







**NOTES FOR F.A. SYSTEM**

1. IN THE WIRING BELOW, THE FIRST DIGIT REPRESENTS THE NO. OF #12 TW WIRES, THE SECOND DIGIT IS THE NO. OF #14 TW WIRES.
2. IN THE MANUAL STATION CODE [E.g. 112], THE FIRST NO. REPRESENTS THE ALERT SIGNAL, THE SECOND NO. IS THE FLOOR SIGNAL, & THE THIRD, THE NO. OF THAT STATION.
3. SIMILARLY, FOR THE AUTOMATIC STATION CODE [E.g. 112], THE FIRST NUMBER IS THE ALERT SIGNAL, & THE SECOND IS THE FLOOR.
4. CAPITAL LETTERS BY FA HORN SYMBOLS INDICATE TO WHICH HORN CIRCUIT THAT PARTICULAR SIGNAL IS CONNECTED TO.

**WATER SCHEDULE**

NO.	DESCRIPTION	PH.	CLASSIFICATION	TYPE	QTY.	CONTROL	REMARKS
1	Water Pump	1/2"	1/2"	1/2"	1/2"	1/2"	Control in "SW-1"
2	Water Pump	1/4"	1/4"	1/4"	1/4"	1/4"	Control in "SW-2"
3	Water Pump	1/2"	1/2"	1/2"	1/2"	1/2"	Control in "SW-3"
4	Water Pump	1/2"	1/2"	1/2"	1/2"	1/2"	Control in "SW-4"
5	Water Pump	1/2"	1/2"	1/2"	1/2"	1/2"	Control in "SW-5"
6	Water Pump	1/2"	1/2"	1/2"	1/2"	1/2"	Control in "SW-6"
7	Water Pump	1/2"	1/2"	1/2"	1/2"	1/2"	Control in "SW-7"
8	Water Pump	1/2"	1/2"	1/2"	1/2"	1/2"	Control in "SW-8"
9	Water Pump	1/2"	1/2"	1/2"	1/2"	1/2"	Control in "SW-9"
10	Water Pump	1/2"	1/2"	1/2"	1/2"	1/2"	Control in "SW-10"
11	Water Pump	1/2"	1/2"	1/2"	1/2"	1/2"	Control in "SW-11"
12	Water Pump	1/2"	1/2"	1/2"	1/2"	1/2"	Control in "SW-12"
13	Water Pump	1/2"	1/2"	1/2"	1/2"	1/2"	Control in "SW-13"
14	Water Pump	1/2"	1/2"	1/2"	1/2"	1/2"	Control in "SW-14"
15	Water Pump	1/2"	1/2"	1/2"	1/2"	1/2"	Control in "SW-15"
16	Water Pump	1/2"	1/2"	1/2"	1/2"	1/2"	Control in "SW-16"
17	Water Pump	1/2"	1/2"	1/2"	1/2"	1/2"	Control in "SW-17"
18	Water Pump	1/2"	1/2"	1/2"	1/2"	1/2"	Control in "SW-18"
19	Water Pump	1/2"	1/2"	1/2"	1/2"	1/2"	Control in "SW-19"
20	Water Pump	1/2"	1/2"	1/2"	1/2"	1/2"	Control in "SW-20"

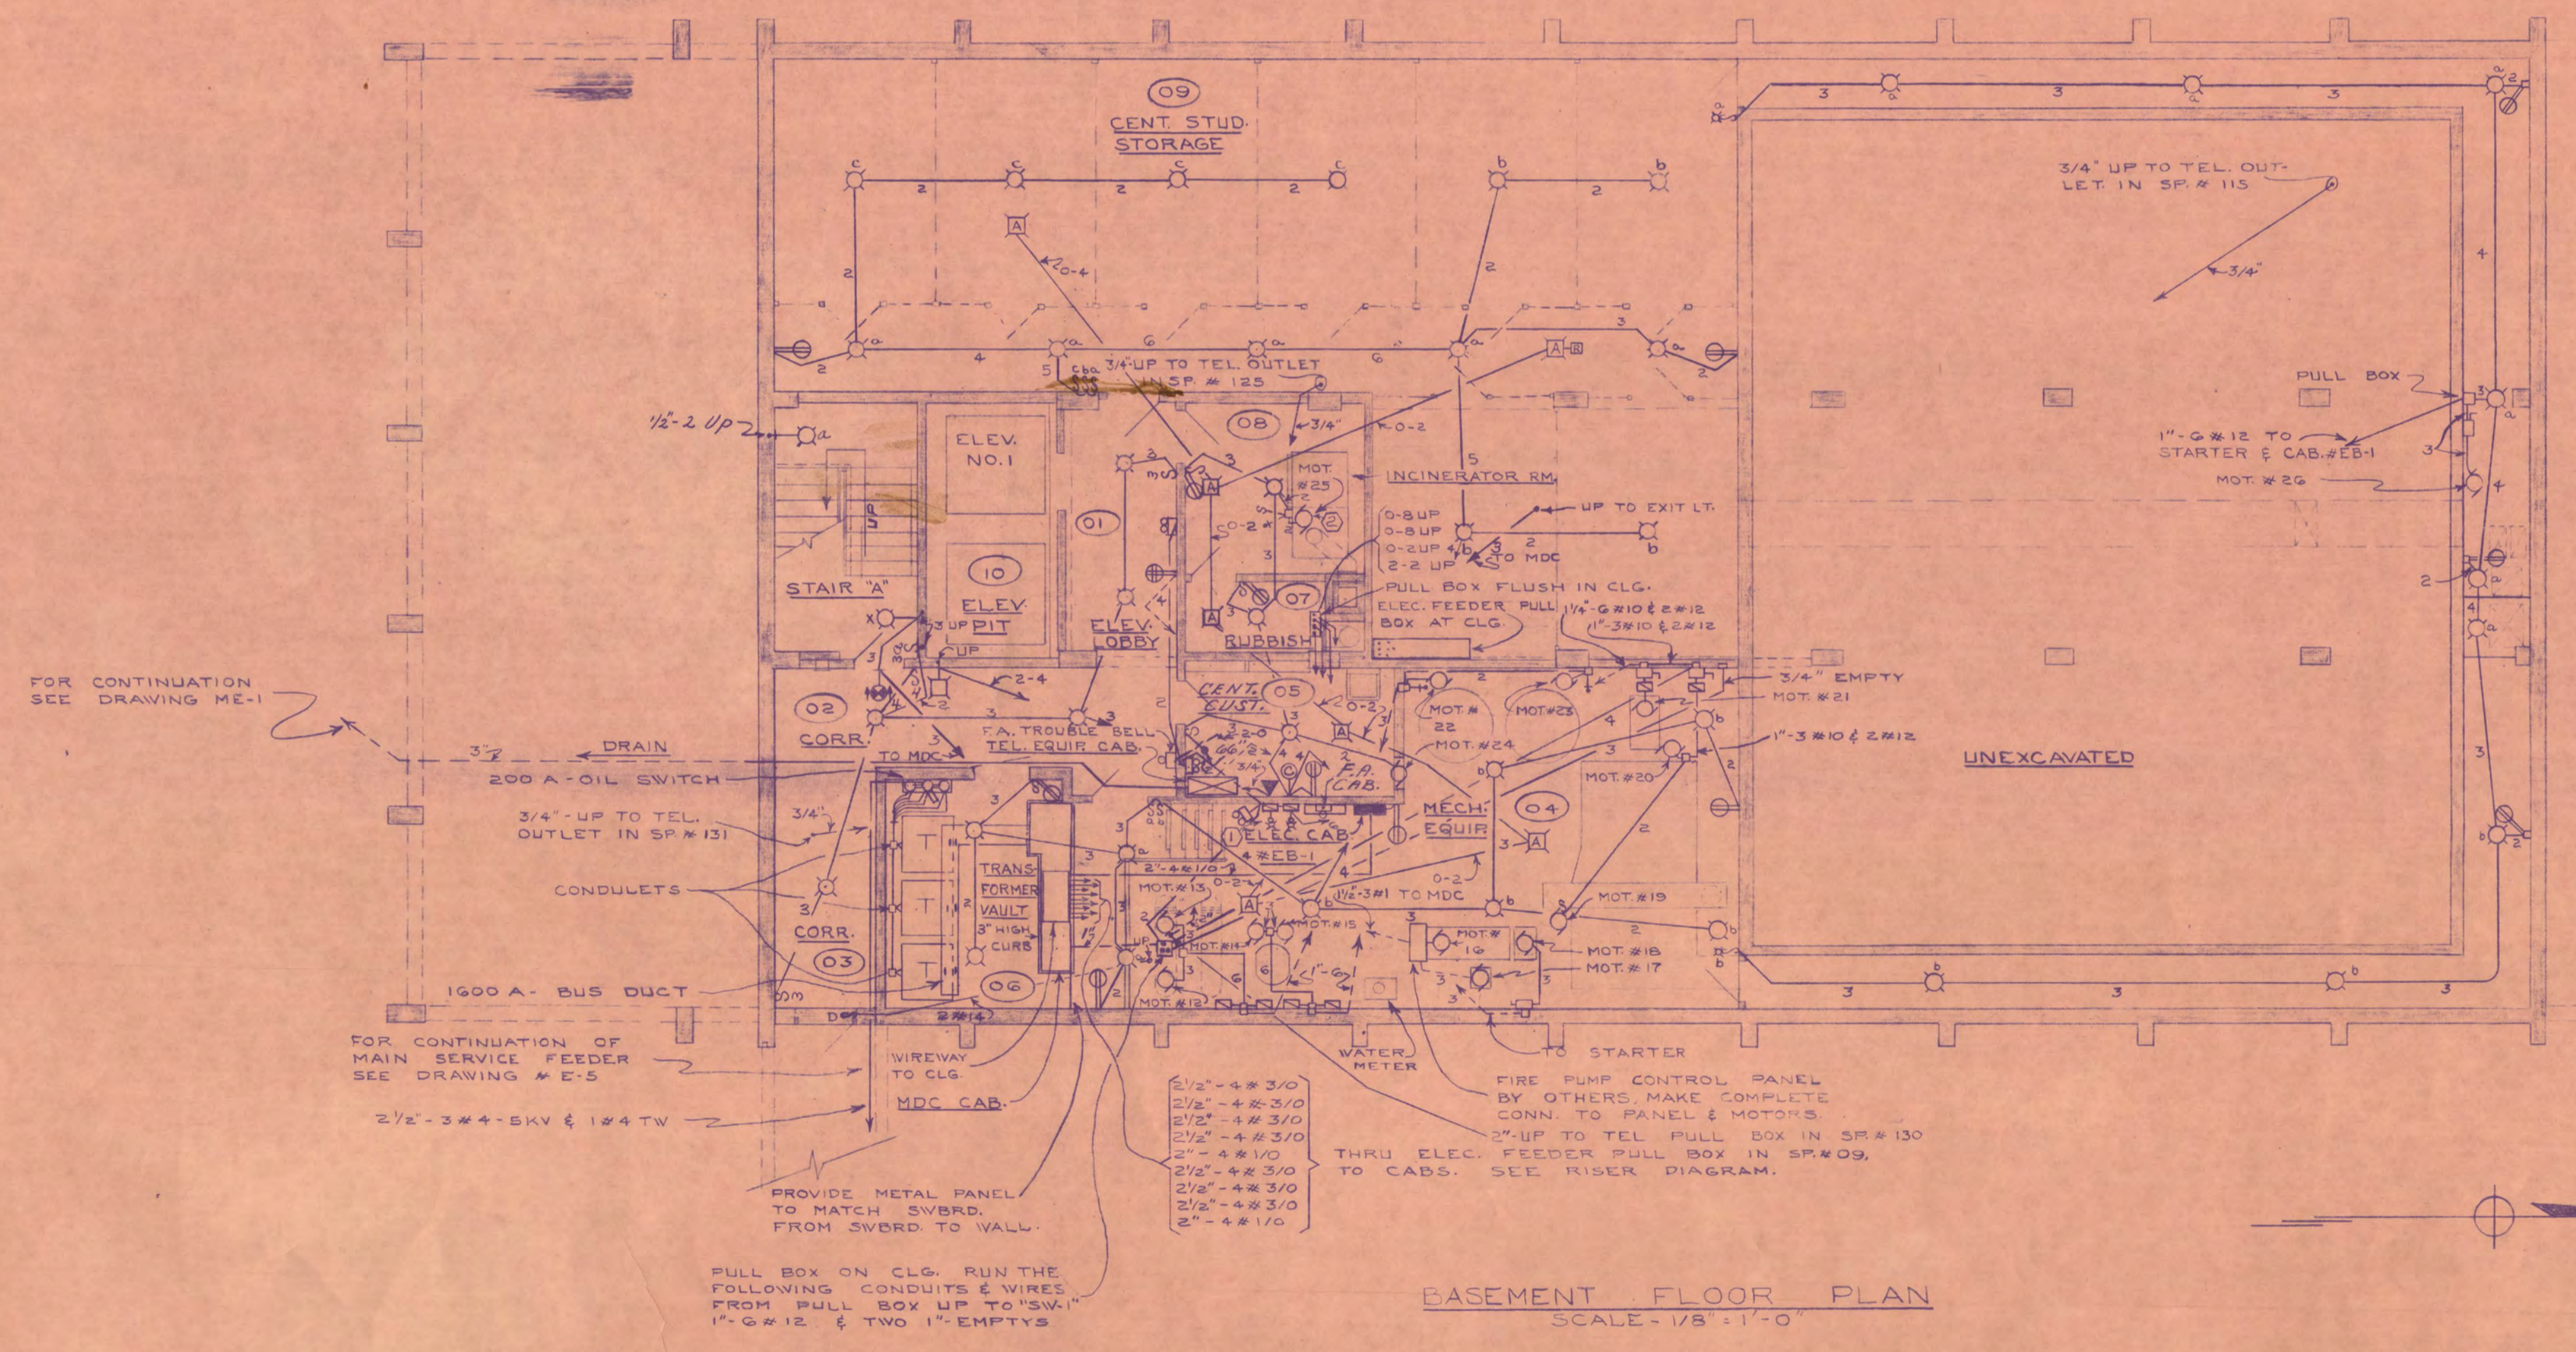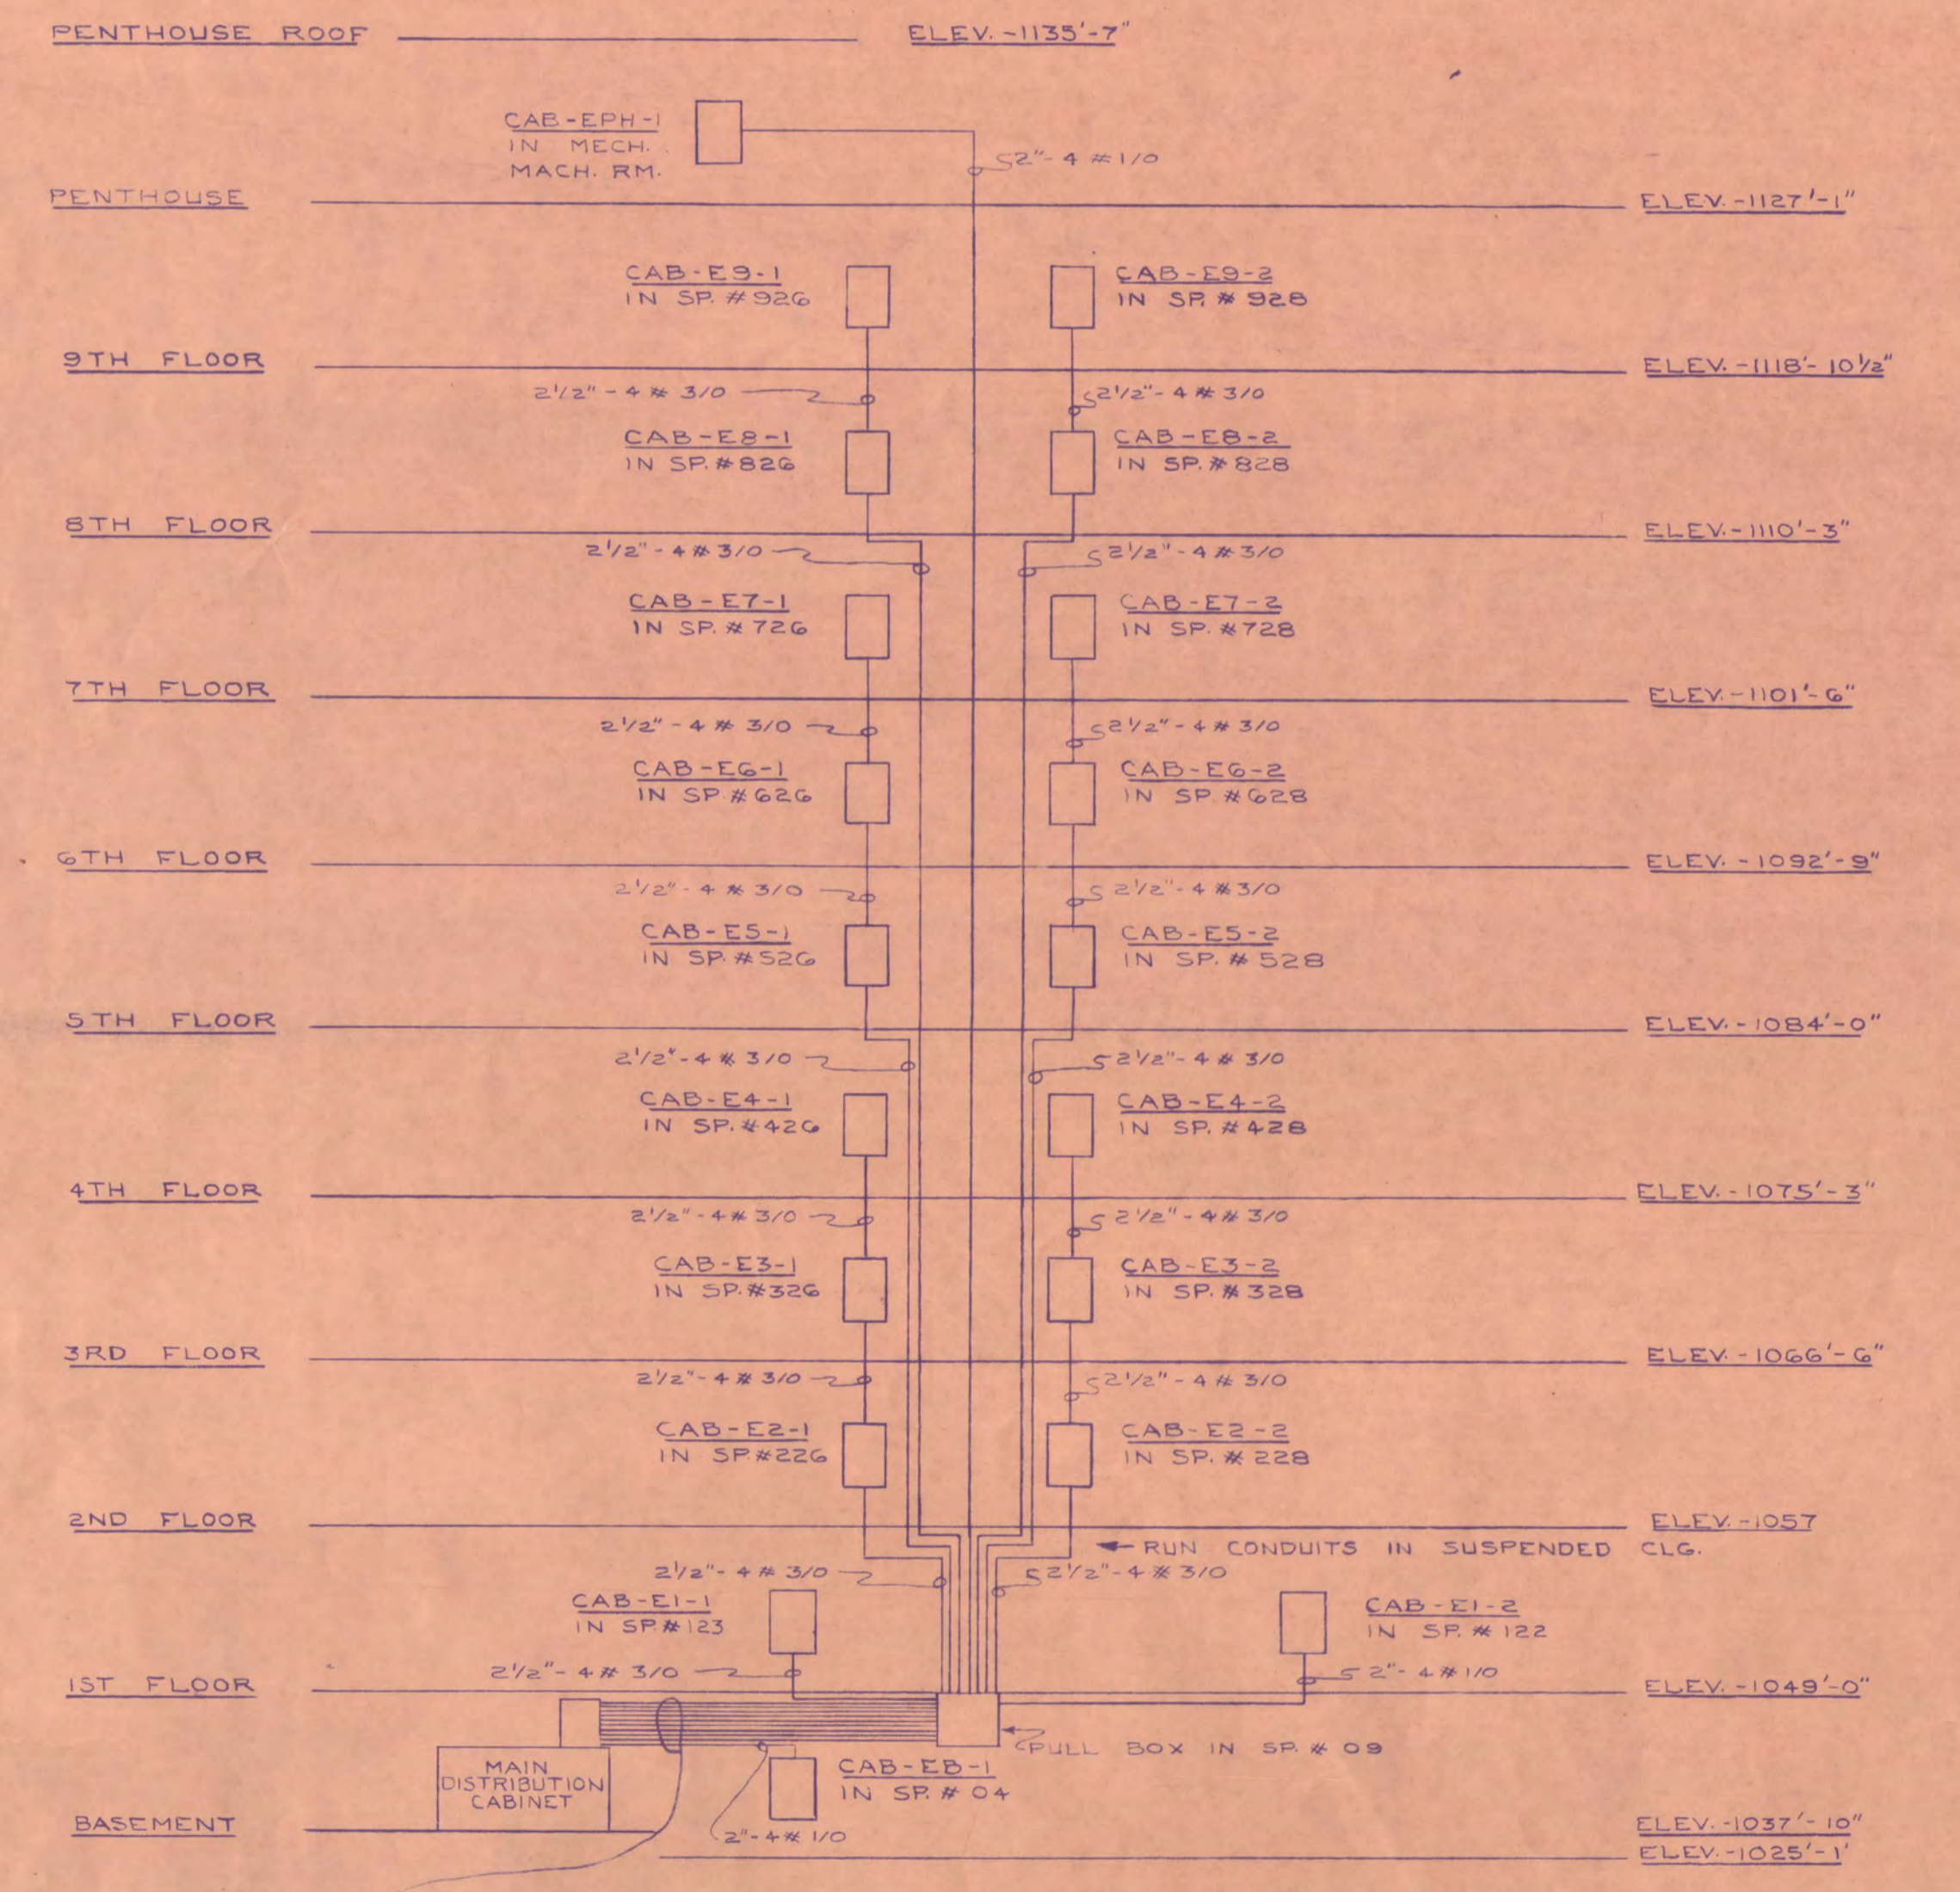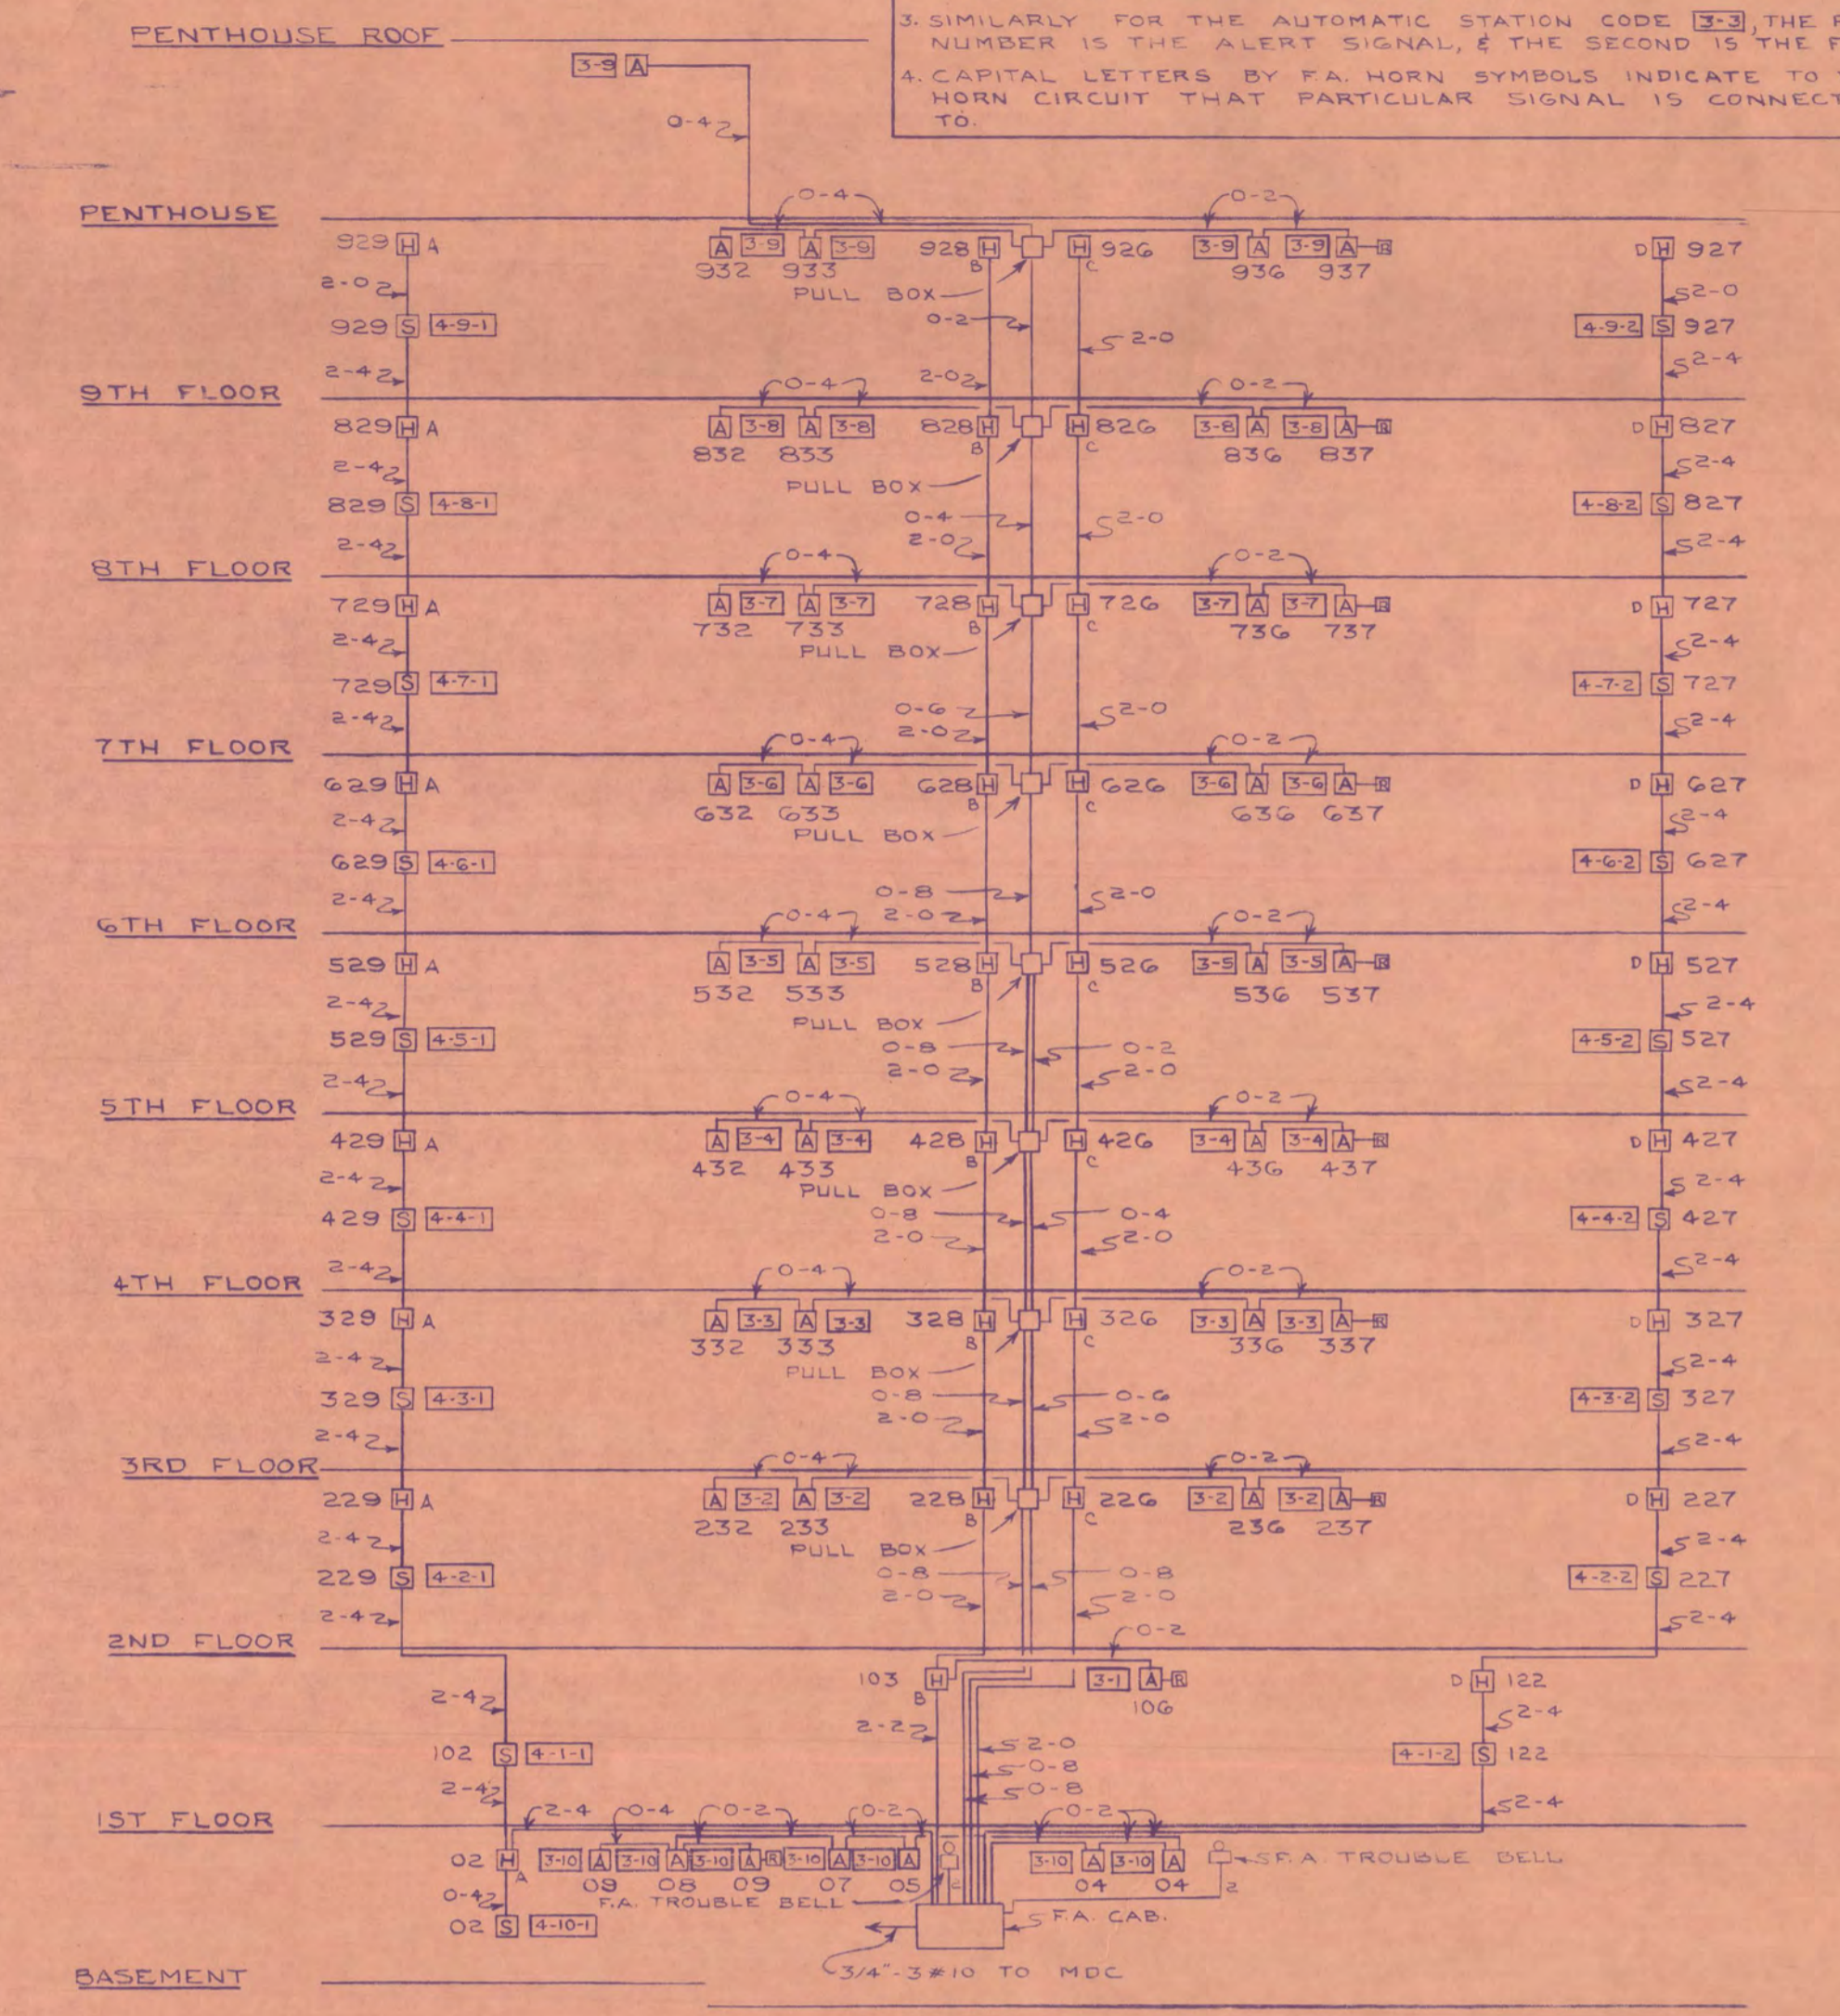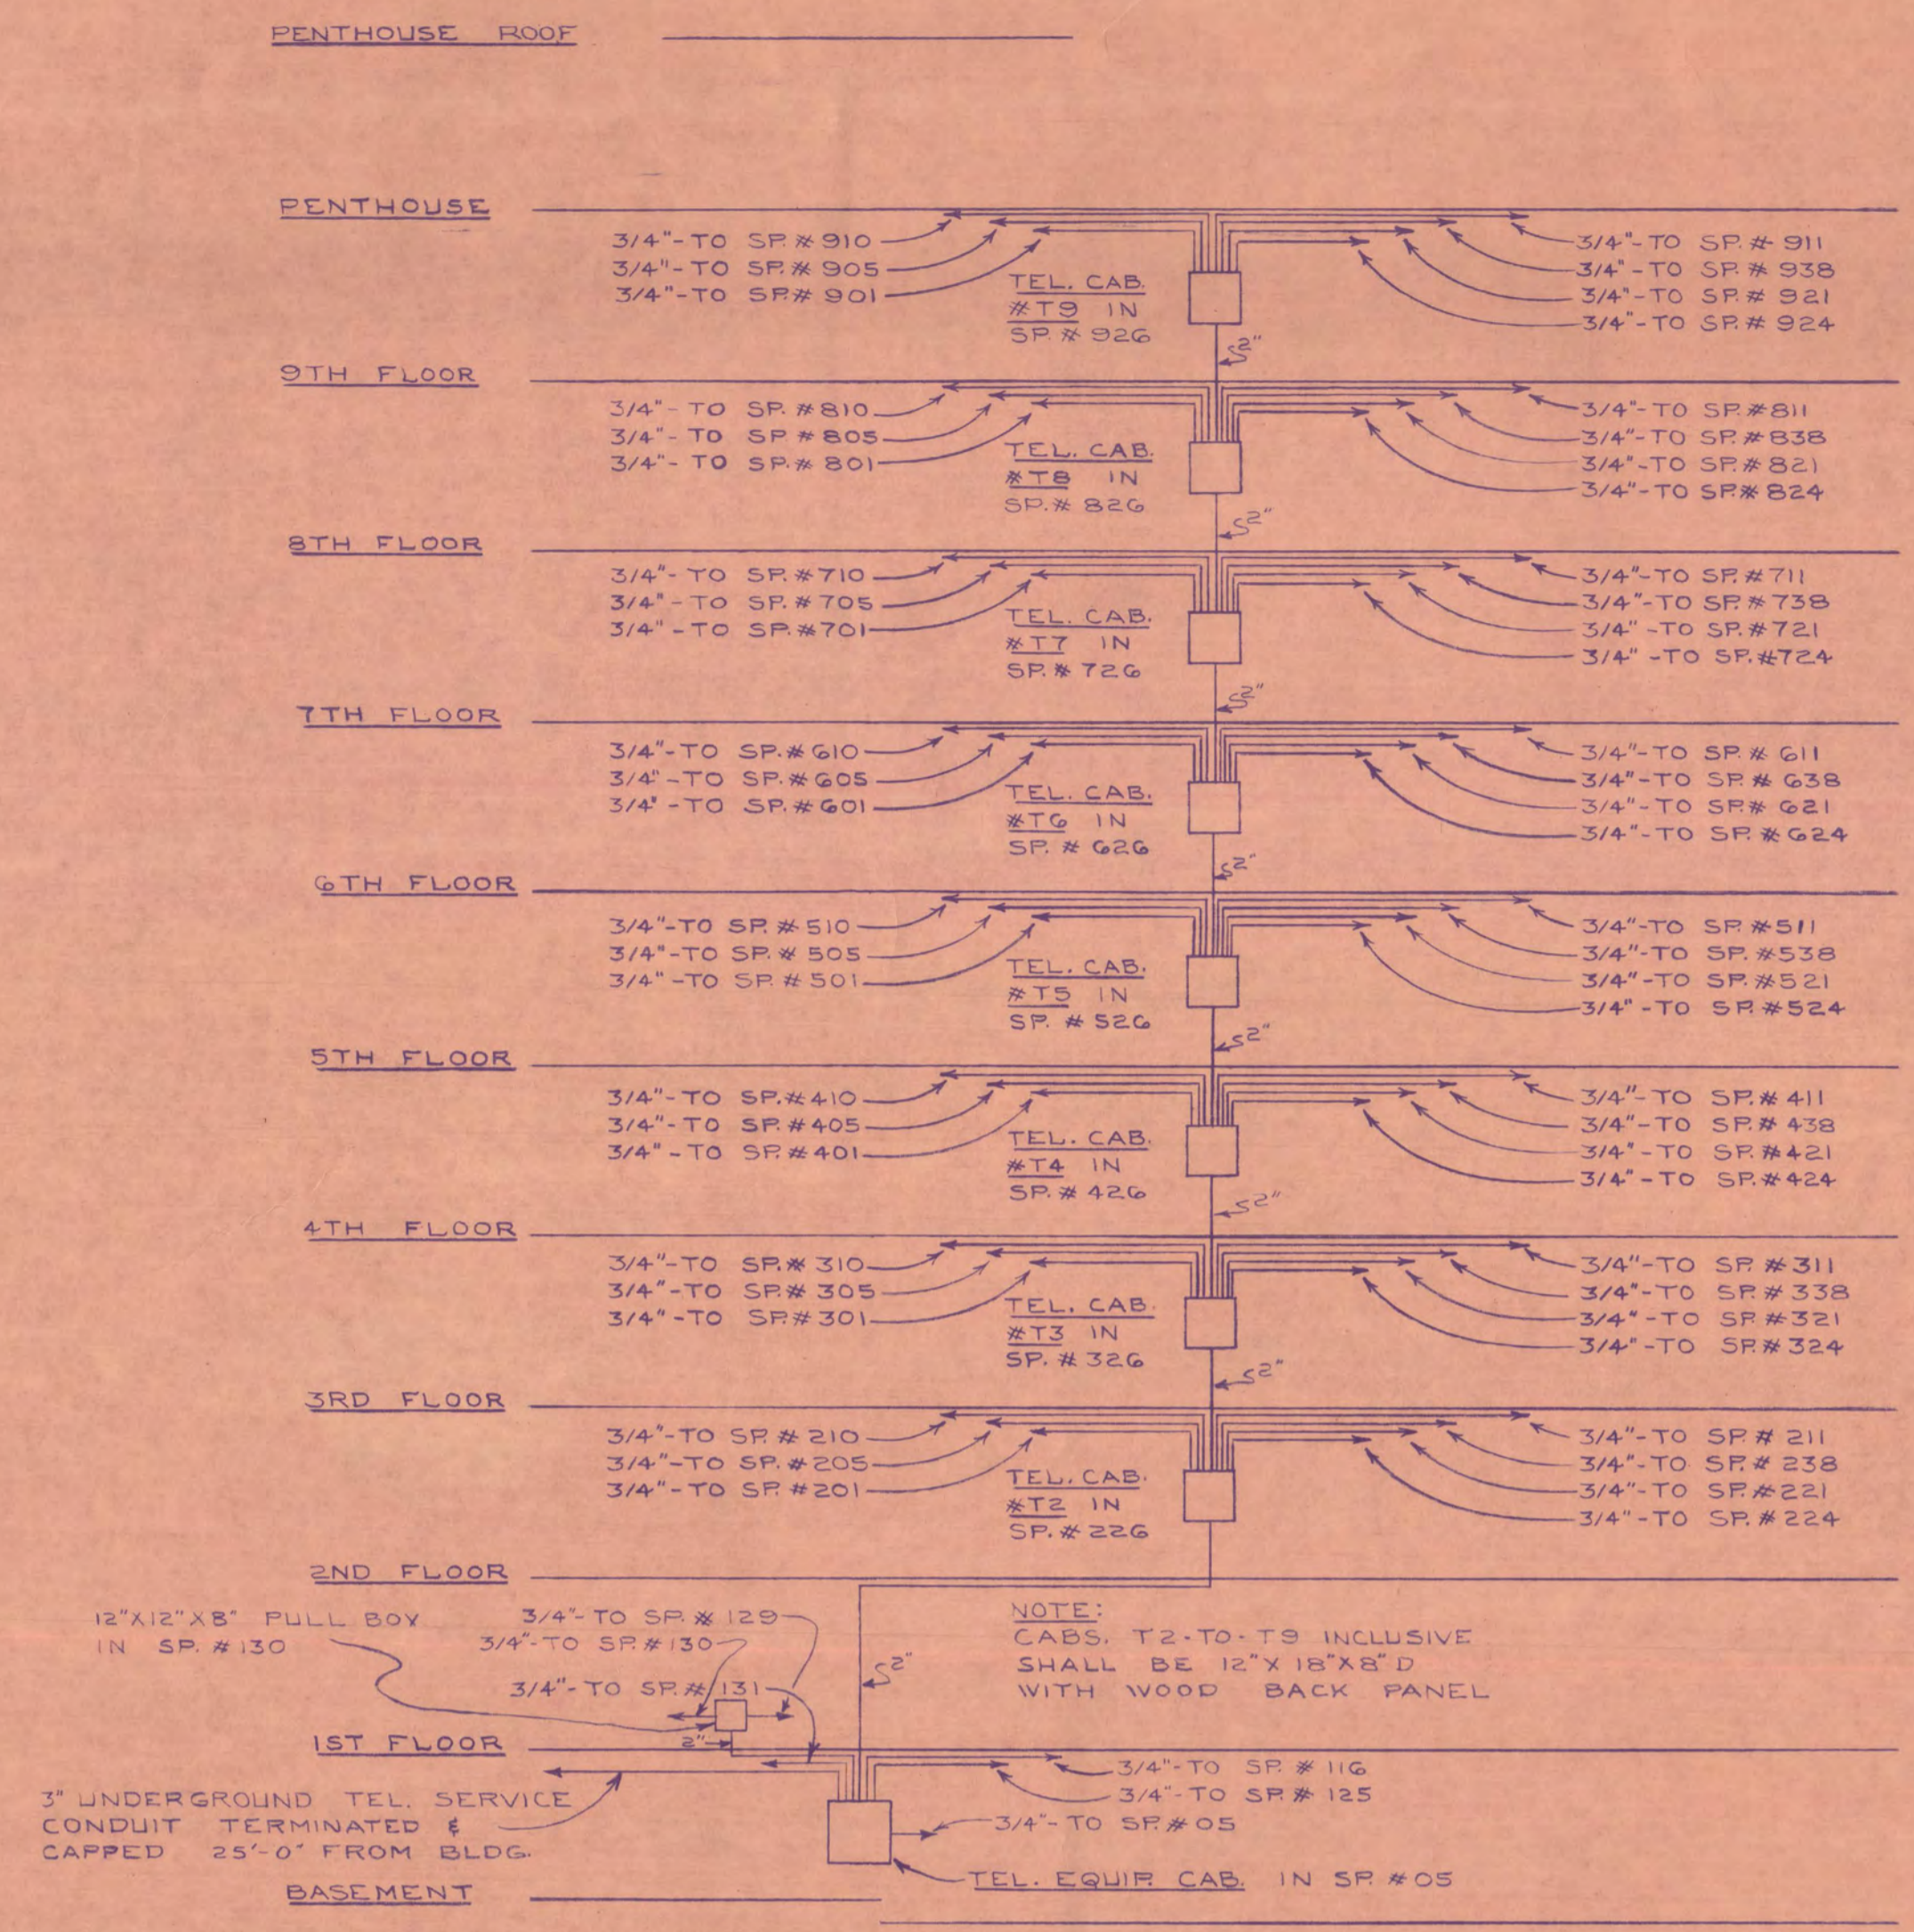

**GIRLS DORMITORY  
ST. CLOUD STATE COLLEGE  
ST. CLOUD, MINNESOTA**


PROJECT NO. 1263-7  
DATE: 5/1/64  
DRAWN BY: [Signature]  
CHECKED BY: [Signature]  
APPROVED BY: [Signature]

**JACKSON HAHN ASSOCIATES, INC.**  
ST. CLOUD, MINNESOTA

**DR. SCHELEN MATYRON  
& ASSOCIATES, INC.**  
CONSULTING ENGINEERS  
1011 CLARK AVENUE, ST. CLOUD, MINNESOTA 56301


PROJECT NO. E-1A



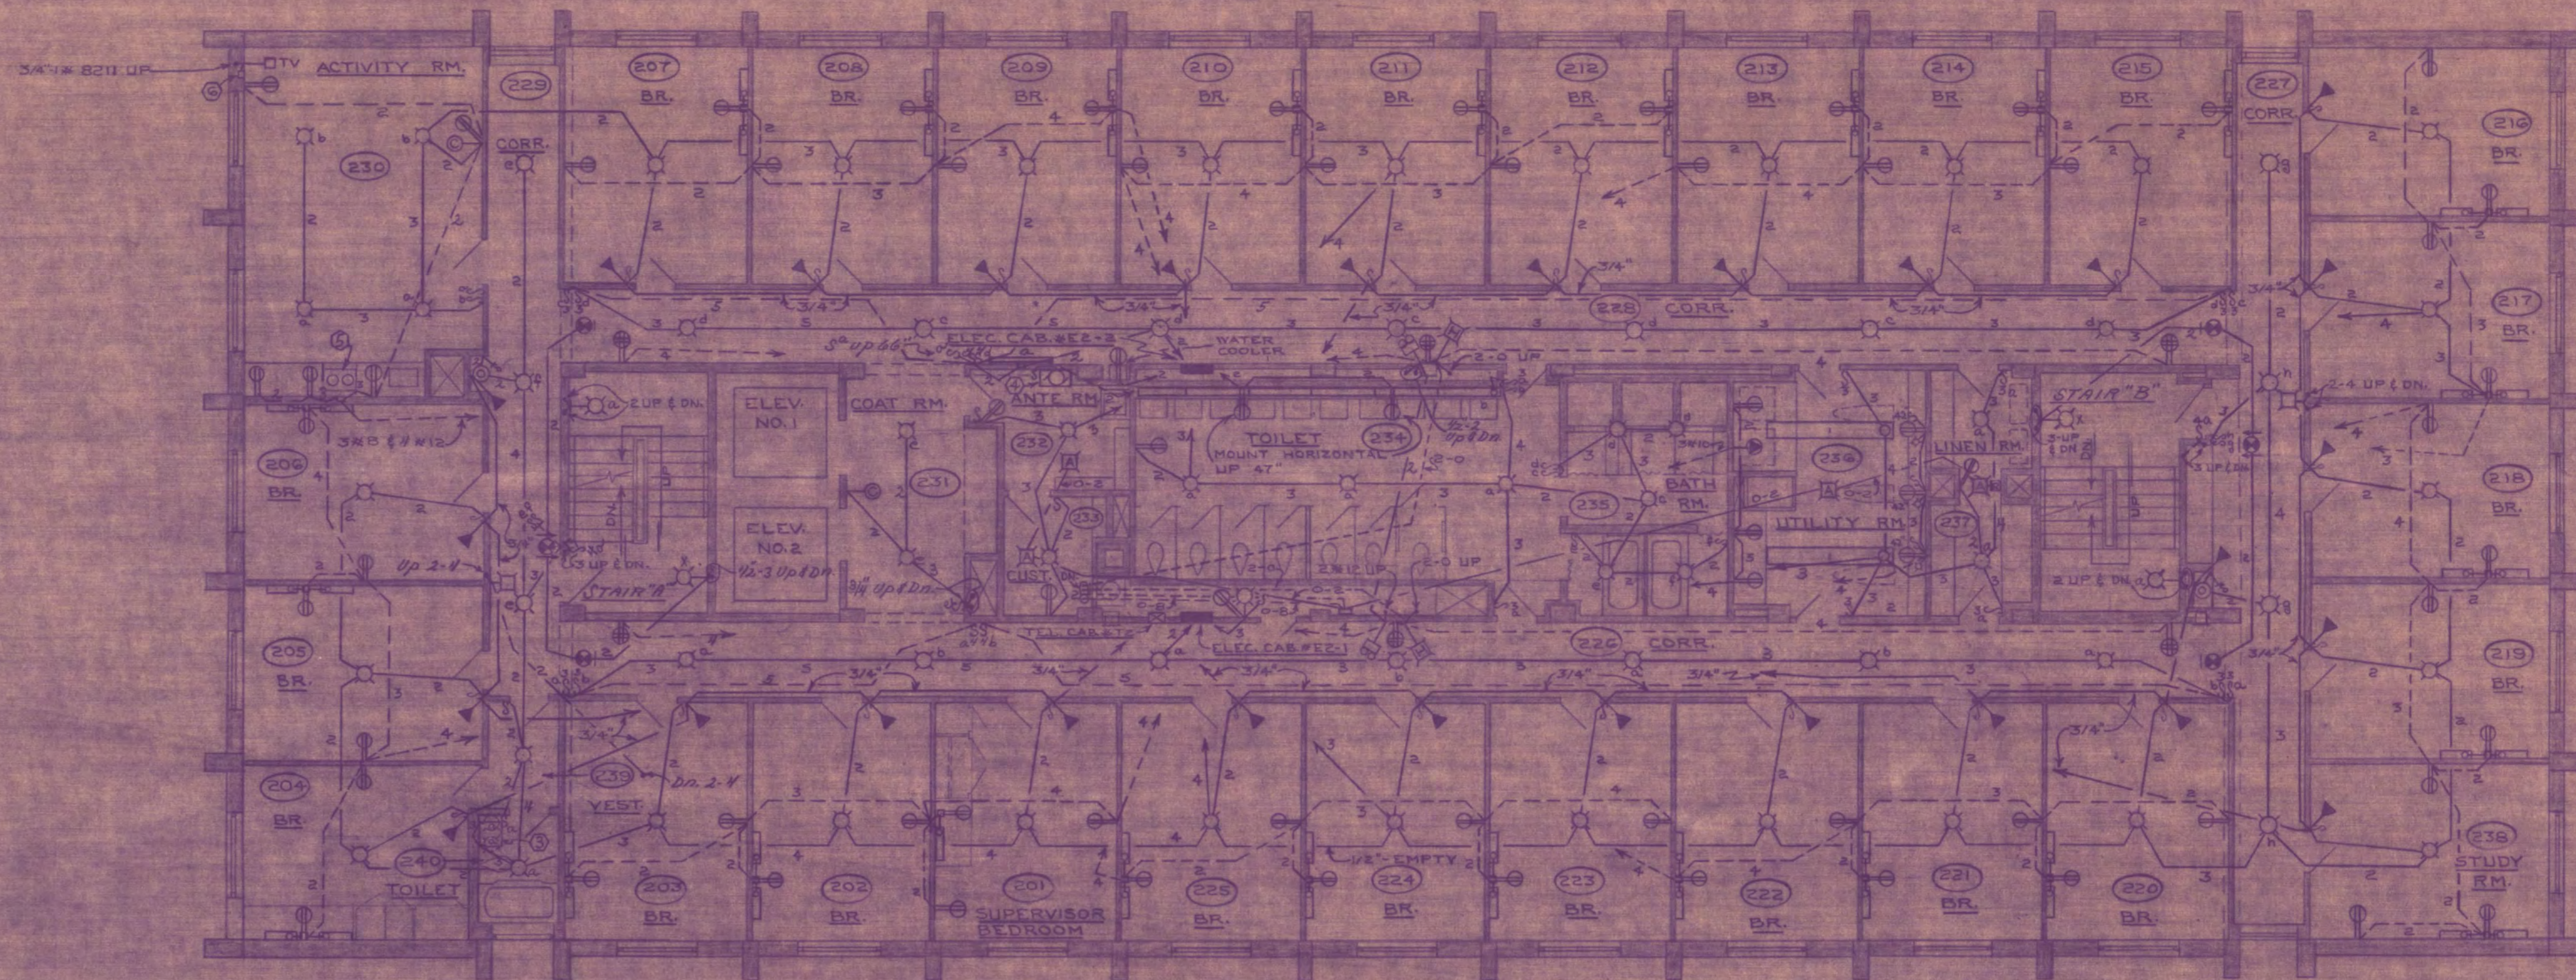


SECOND FLOOR PLAN  
SCALE - 1/8" = 1'-0"

- Legend:
- General and main supply connections to case light fixtures in rooms.
  - Main supply connections to floor-to-ceiling fire - unit type.
  - Main supply connections to window blind lighting fixtures.
  - Main supply connections to heat collector.
  - Main supply connections of 2 1/2" diameter piping for heating in rooms.
  - Main supply connections to electrical equipment.
  - Special lighting with single and flush plates, 3/4" conduit.
  - 3/4" pipe up to 10' height in mechanical rooms in vestibules.
  - Main supply connections to main floor lighting. Used and installation of electrical equipment.

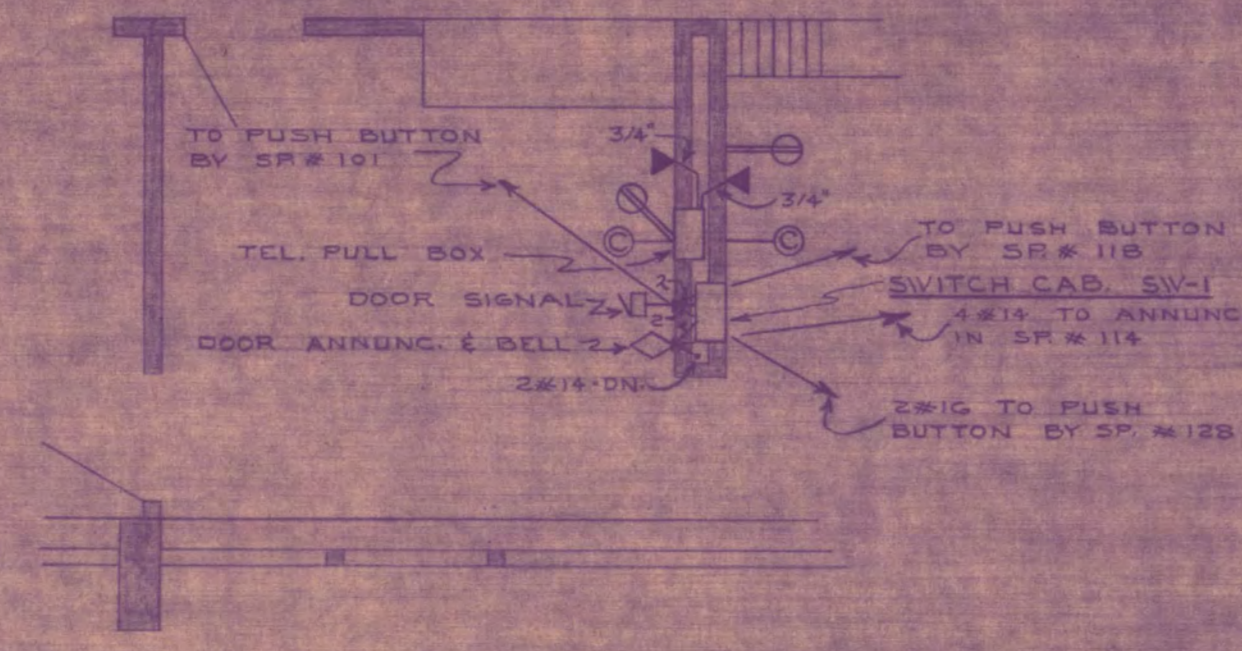

PLAN SHOWING EQUIP. ON WALL BETWEEN SP # 129 & 130  
SCALE - 1/8" = 1'-0"

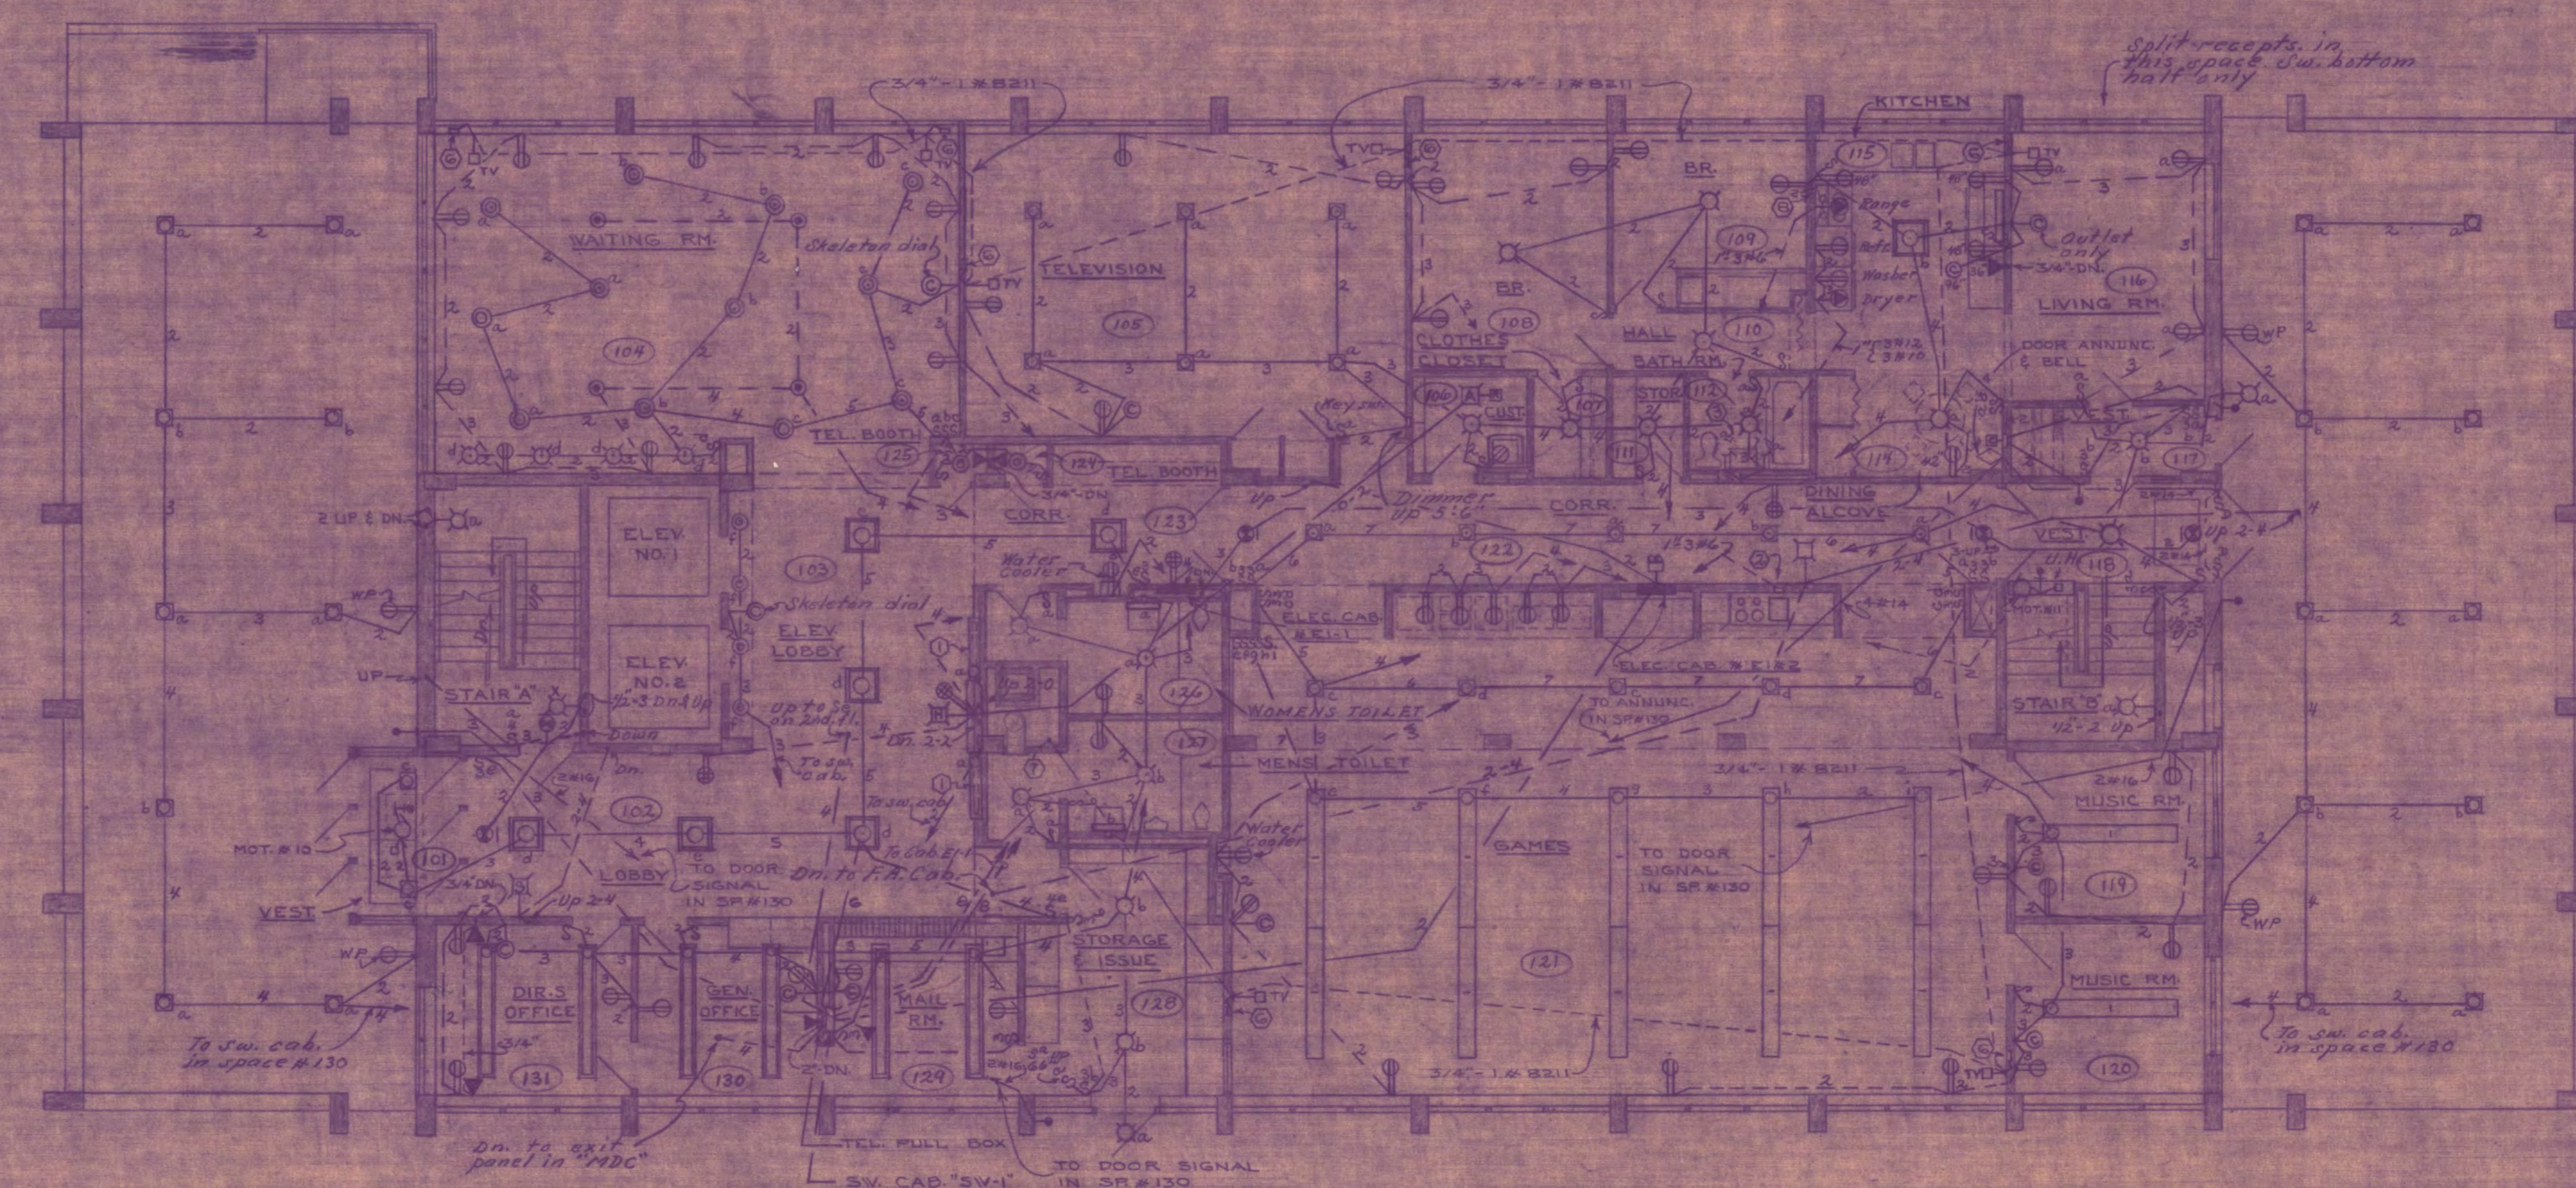

FIRST FLOOR PLAN  
SCALE - 1/8" = 1'-0"



<b>GIRLS DORMITORY ST. CLOUD STATE COLLEGE ST. CLOUD, MINNESOTA</b>	
WORK NO. 1263-7	JACKSON MAHN ASSOCIATES, INC. ARCHITECTS ST. CLOUD, MINNESOTA
DESIGNED BY E. J. S. L. V. S.	ORR SCHLIMM-WATERON & ASSOCIATES, INC. CONSULTING ENGINEERS 500 WEST AVENUE, ST. CLOUD, MINN.
DATE 8/1/64	PROJECT NO. E-1A
APPROVED BY [Signature]	
APPROVED BY [Signature]	
APPROVED BY [Signature]	